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501 Perspectives


STRUCTURAL DOCUMENTATION

Structural Engineering: PS1, Details & Calculations

PRODUCT SPECIFICATIONS

A. XLAM CLT technical documents B. ECOPLY SHADOWCLAD specification and installation guide 2021 C. ARDEX 3000X Data Sheet D. THERMAKRAFT Roofing & Cladding Underlay Technical Specifications

- E. ENERTHERM PIR solid insulation
- F. DEKTITE Flashing Systems Handbook
- G. ALYSINTE 5-rib translucent roofing
- H. FIRENZO Viking Woodburner& Flue installation instructions
- I. HOPERGY Solar PV and system installation and manual

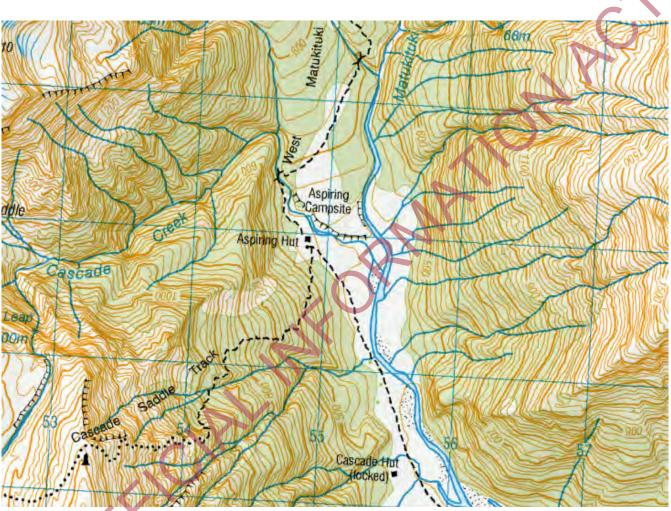

Additional Standard Details are attached to the specification. These are part of the Building Consent documentation set.

SUPPORTING DOCUMENTS

- A. On-site Waste Water Report (Grey-water only)
- **B.** Fire Report
- C. Separate Agreement between the Department of Conservation (DoC) & the New Zealand Alpine Club (NZAC)
- D. Manufacturer's Specifications, Instructions & Data Sheets, NZ Standards and NZ Building Code Acceptable Solutions as referenced on the drawings, listed here or on the contents page of the written specification
- E. All other fittings & materials' Manufacturer's Specifications, NZ Standards and NZ Building Code Acceptable Solutions as required for construction
- F. Referenced DoC Backcountry Hut Procurement Manual Details and Specifications



Drawn: B.A.D. Checked: Kat West Issued: 11 JULY 2022 Status: BUILDING CONSENT Revised


Attachment 2




Cover Sheet & Location


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1 of:24



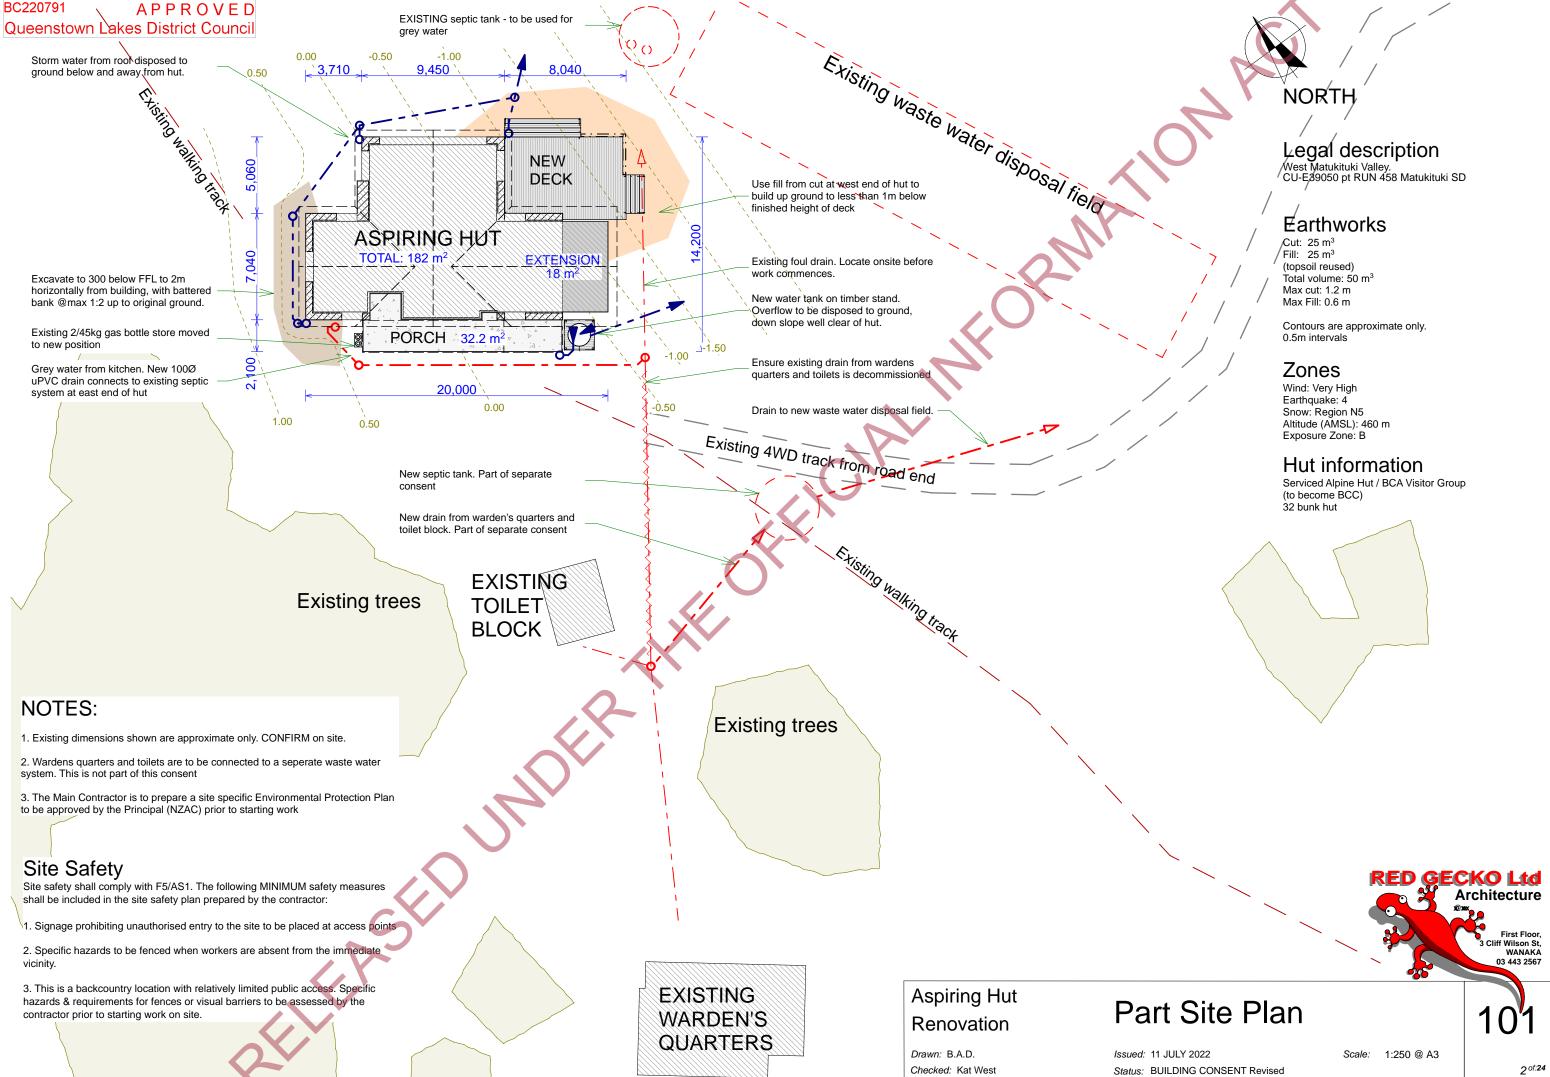

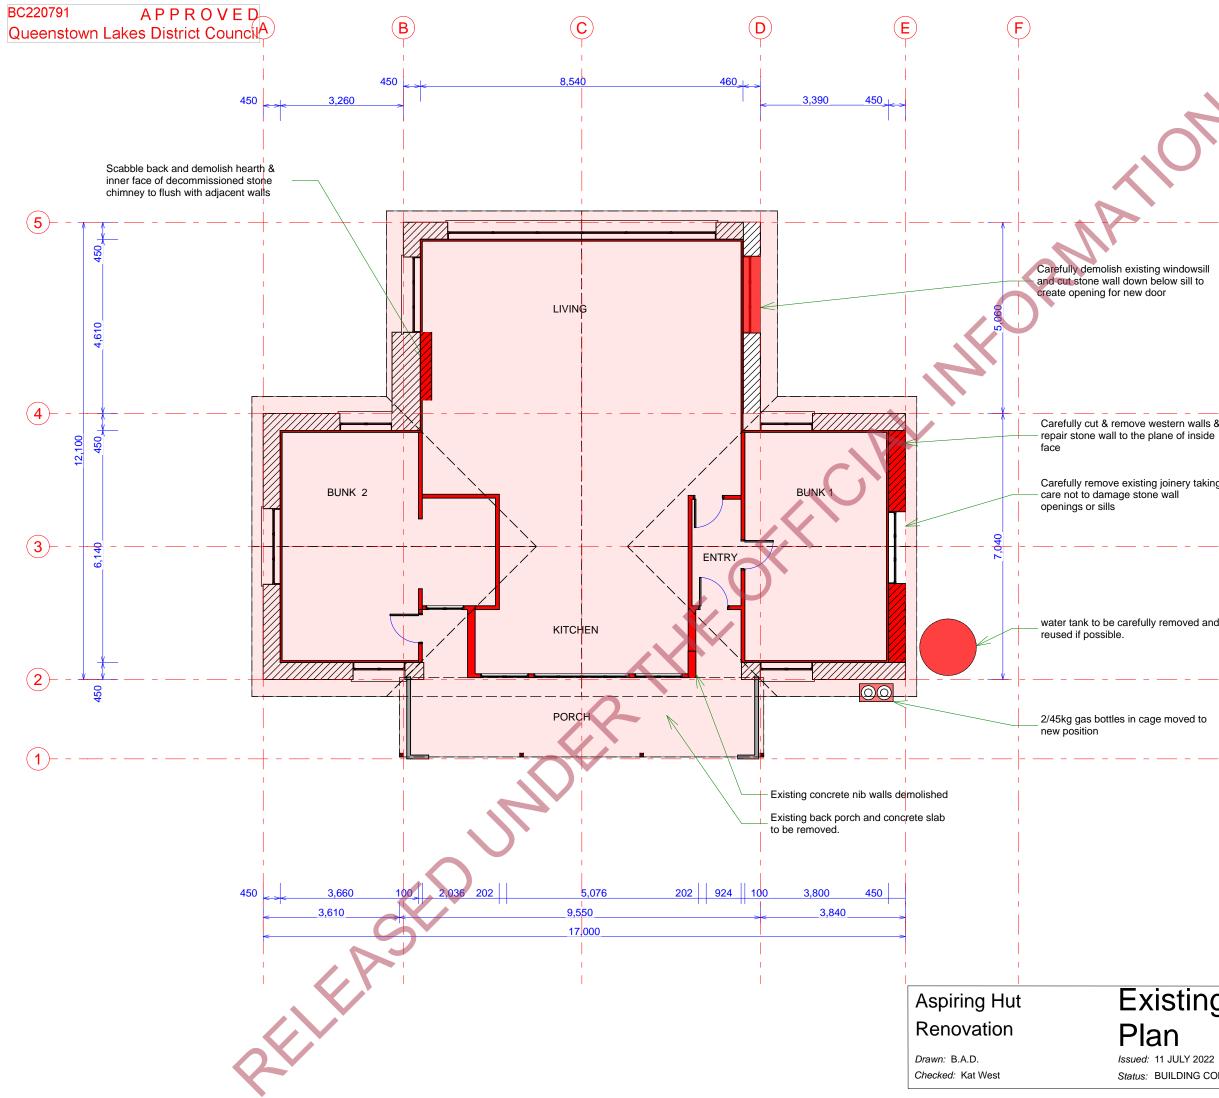7	
2	NORTH
	MATERIALS LEGEND
	Wall: Demolition.
	Schist stone wall to be demolished
owsill ill to	Roof to be demolished
	Other elements to be removed
walls & inside	NOTES 1. All existing structure other than stone walls as shown to be demolished 2. All dimensions are existing and approximate. CONFIRM onsite
y taking	
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ed to	
	RED GECKO Ltd Architecture
ing &	Demolition 102

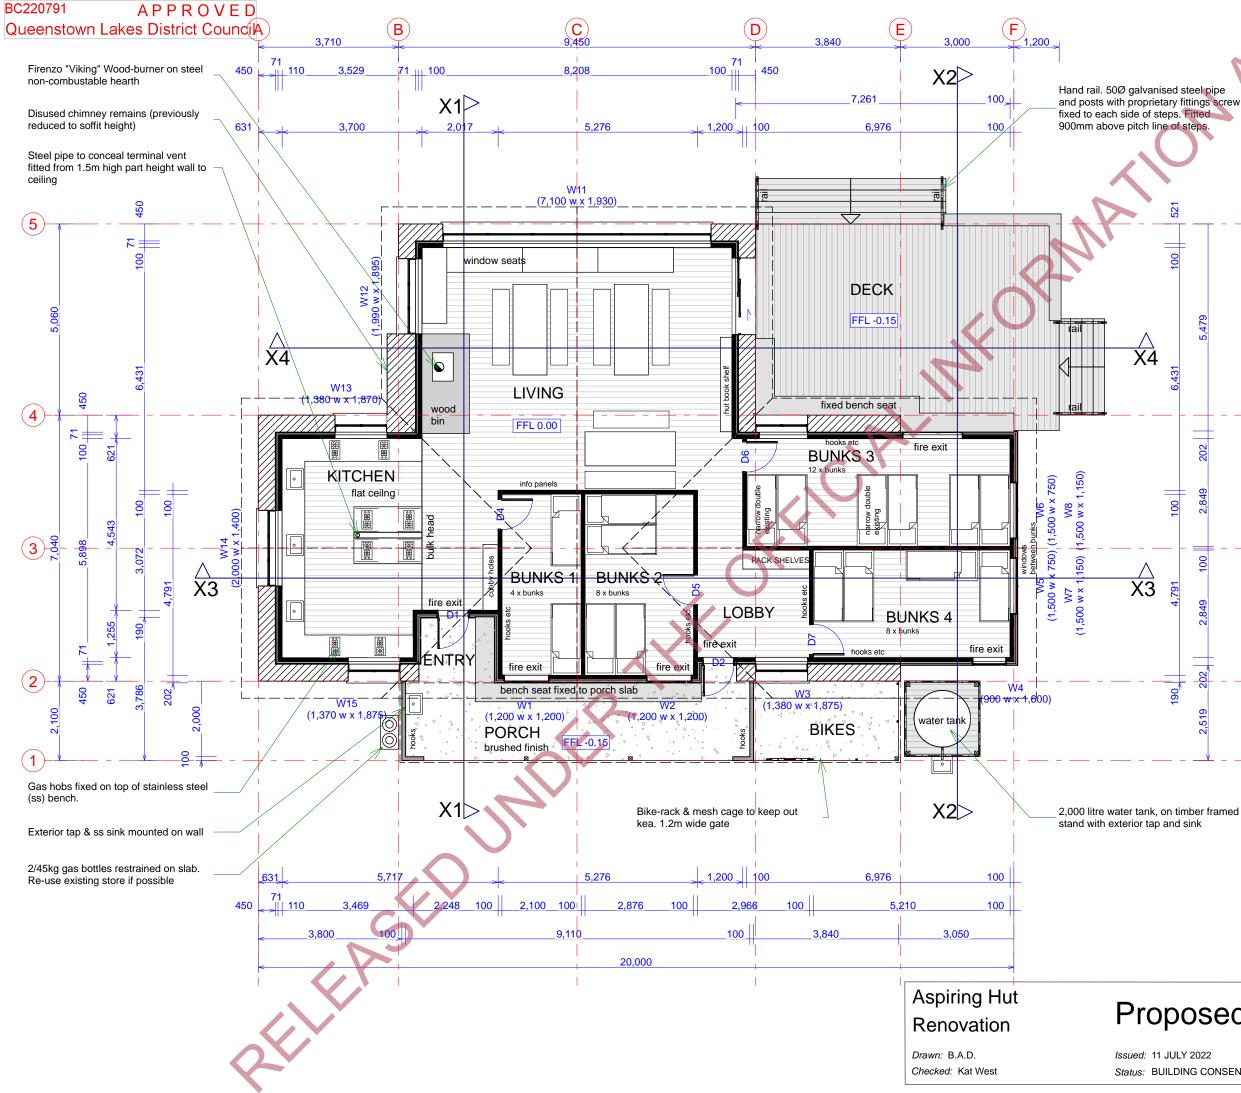

teel pipe	
itted teps.	NORTH
	MATERIALS LEGEND
	CLT Wall 100
	CLT Wall 100 + insulation
	CLT Wall 110 + insulation
5,479	90mm timber framed wall.
	Part height timber framed wall.
	Existing stone wall
202	Plate steel hearth
	Timber Decking
2,849	Concrete Patios
100	CLT Timber Floor
2,849	NOTES
3	1. All interior doors to have 810 wide x 1980 high solid leafs with vision panels.
202	 2. All doors to comply with the Fire Report requirements. — Refer to the written specification for details
2,519	





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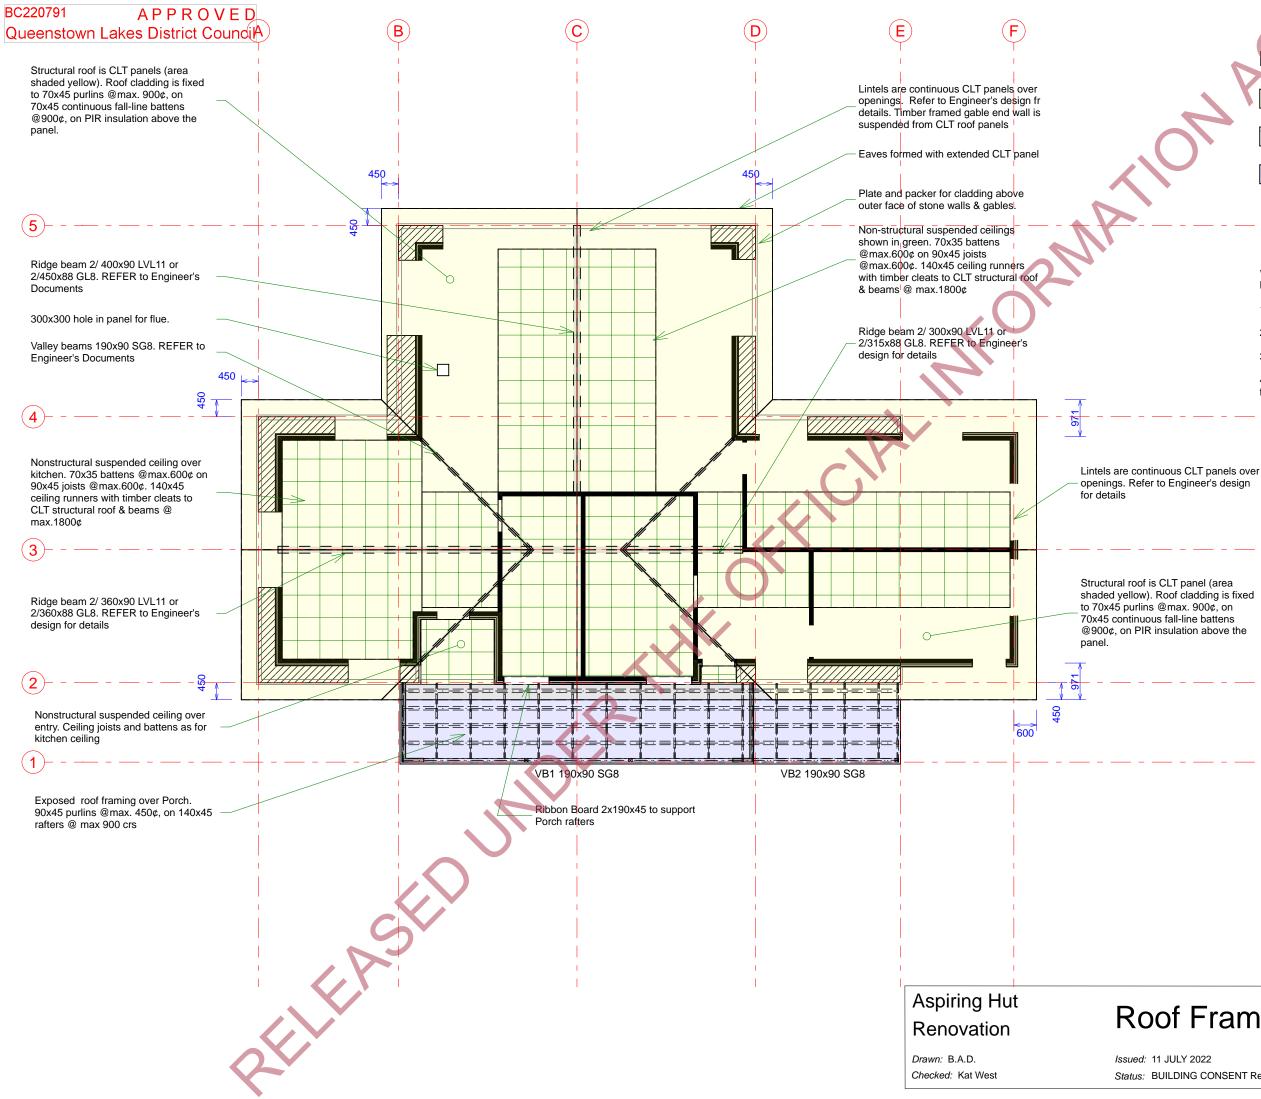
Proposed Floor Plan

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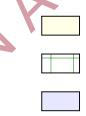
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3/120 CLT panel roof

Non-structural timber framing for flat ceilings

Translucent Roofing: Exposed roof framing

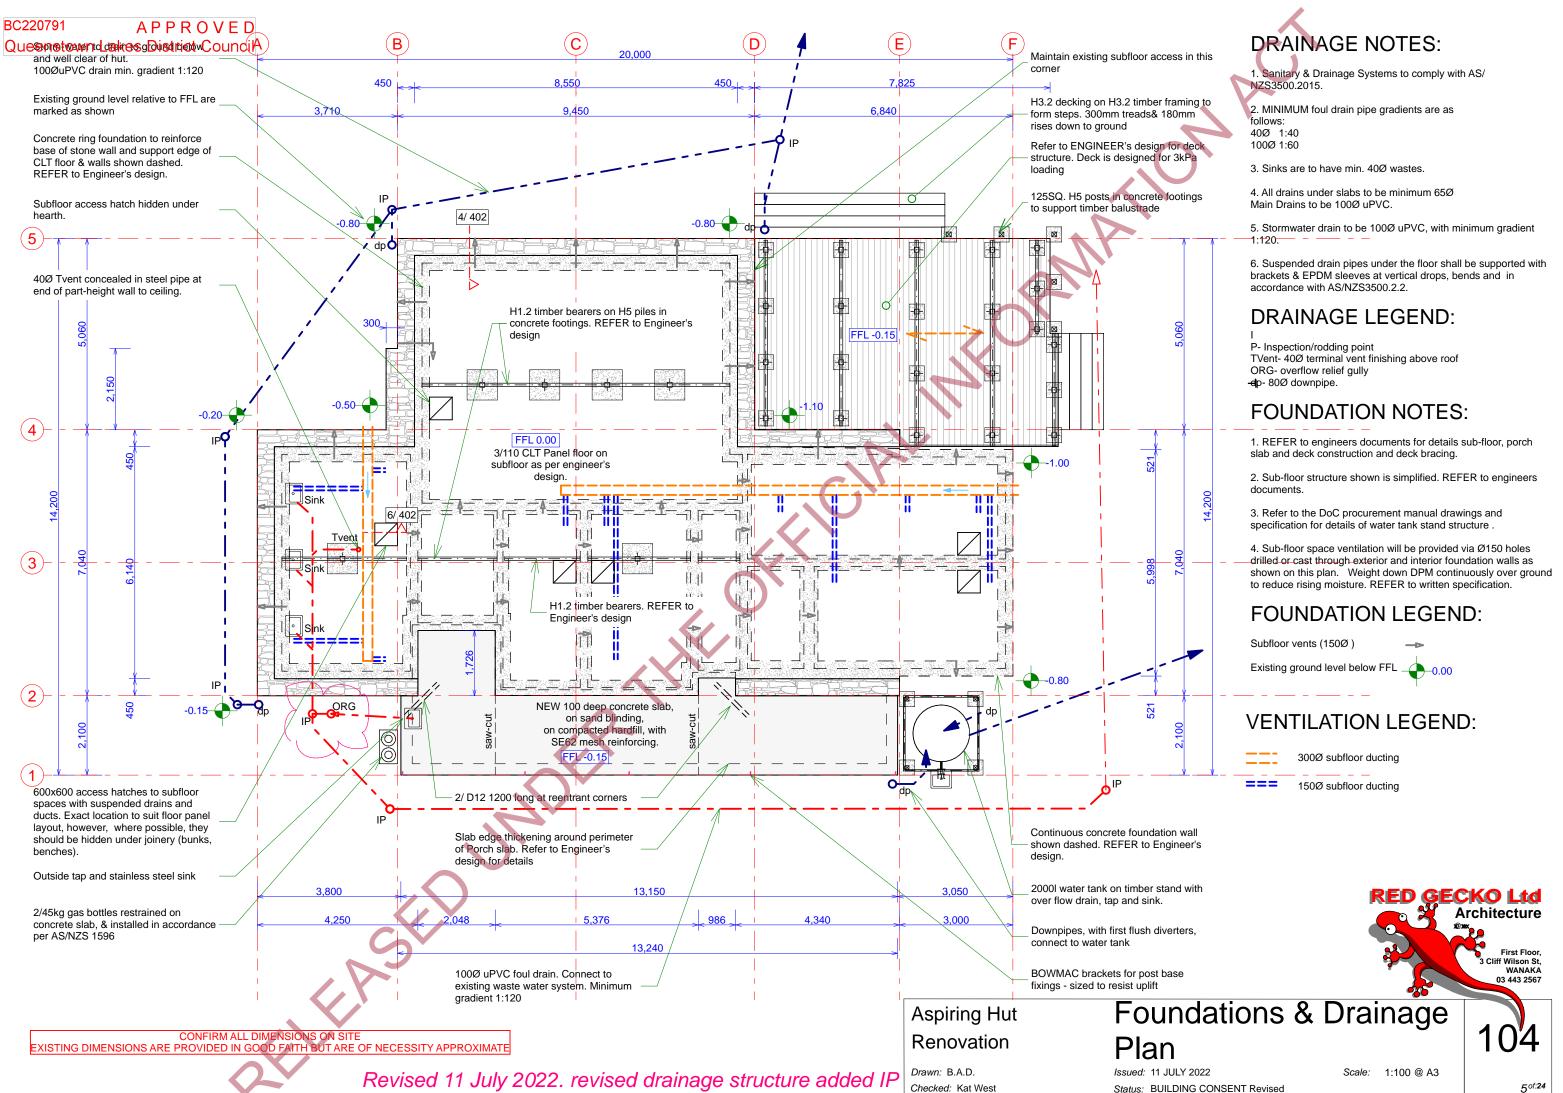ROOF FRAMING NOTES:

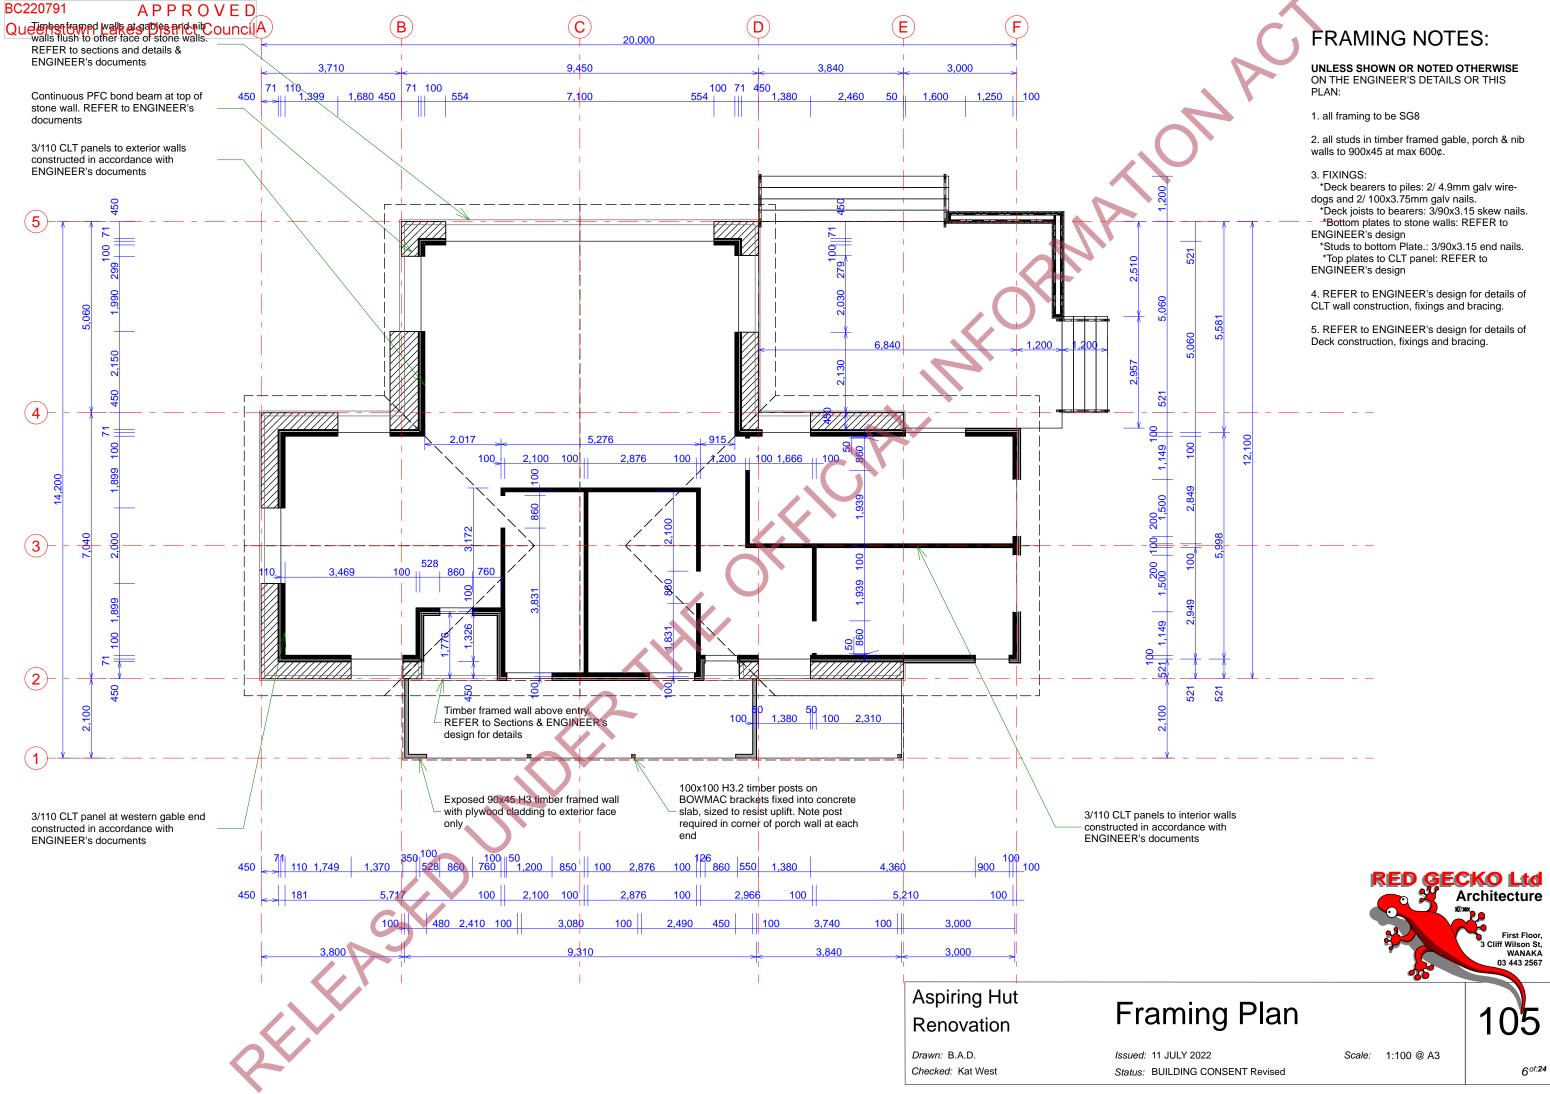***UNLESS SHOWN OR NOTED OTHERWISE ON THE** ENGINEER'S DOCUMENTS OR THESE PLANS:

1. all framing to be SG8


2. FIXINGS: REFER to Engineer's design

3. Roof- plane bracing is provided by CLT panels

4. Refer to the REFER to Engineer's design for roof framing and panel construction details and fixings.



Roof Framing Plan

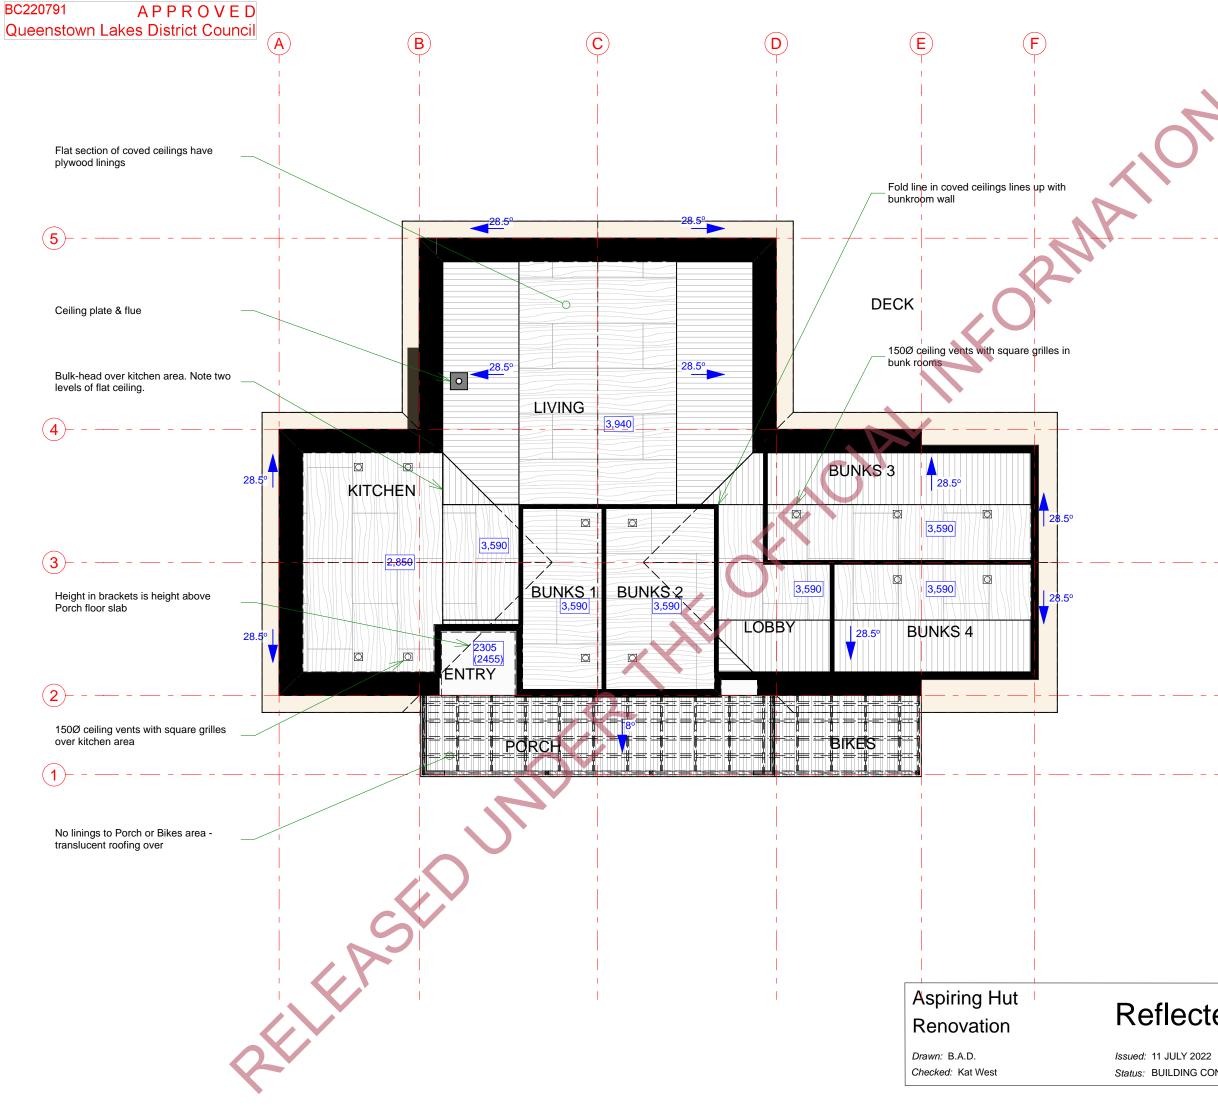

	CEIL	ING LEGEND
1		CLT panel ceilings
5		Plywood ceilings
		Painted cement board ceiling
		Translucent roofing
		Painted CLT panel soffit
	28.5°	Direction of fall for raking ceilings & soffits
	3000	Height above FFL in mm
	\bigcirc	Ceiling grille locations




Reflected Ceiling Plan


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Scale: 1:100 @ A3

07

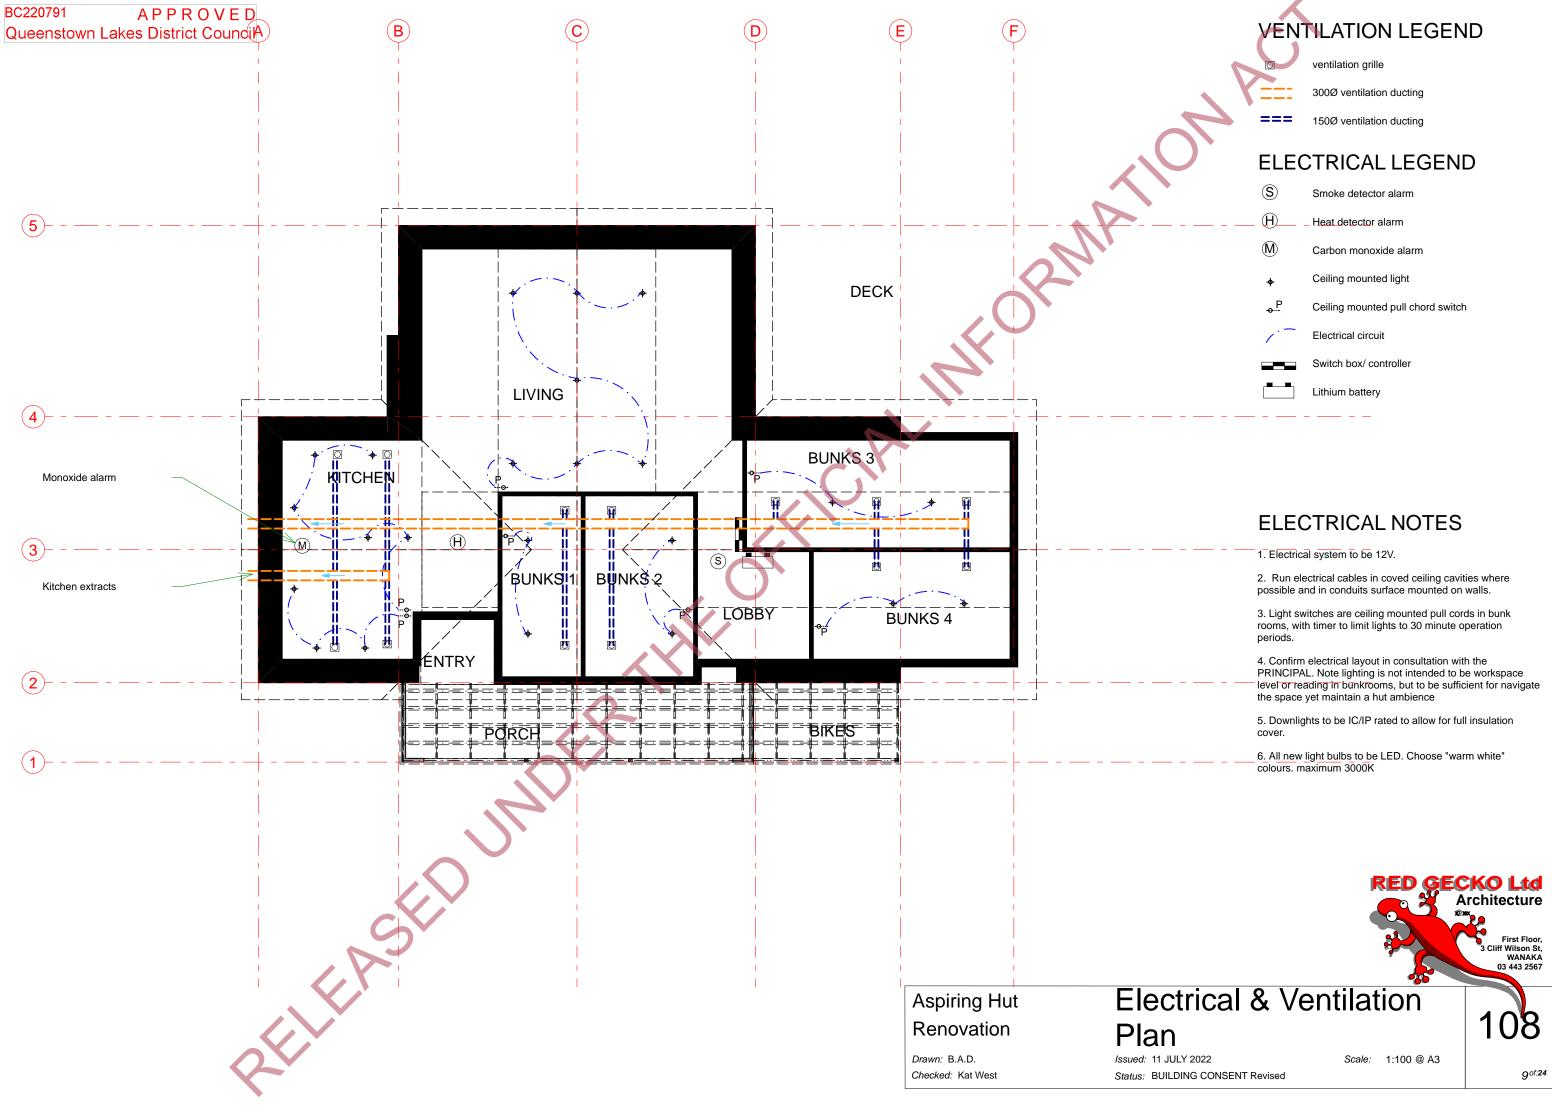

Ø	ventilation grille
	300Ø ventilation ducting
===	150Ø ventilation ducting
ELEC	CTRICAL LEGEND
(s)	Smoke detector alarm
(H)	Heat detector alarm
(M)	Carbon monoxide alarm
\$	Ceiling mounted light
• <u>P</u>	Ceiling mounted pull chord switch
1-	Electrical circuit
	Switch box/ controller
	Lithium battery

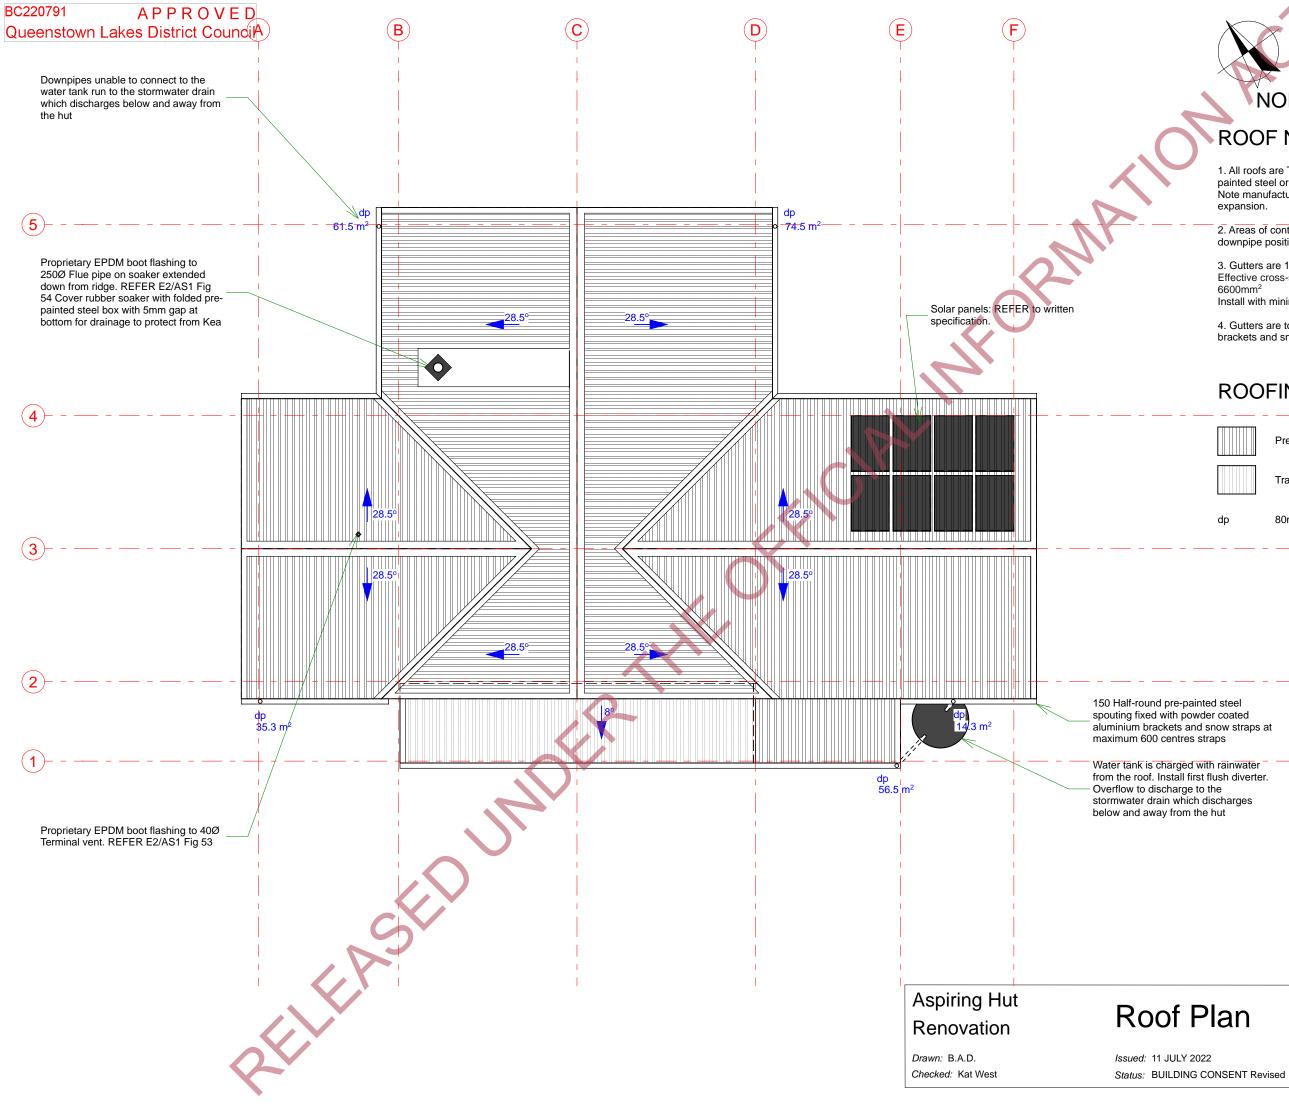

NORTH

ROOF NOTES:

1. All roofs are T-RIB® profile or equivalent long run, prepainted steel or translucent polycarbonate as shown. Note manufacturers fixing requirements for thermal expansion.

2. Areas of contributing rainfall catchment shown next to downpipe position. Total = 242 m^2

3. Gutters are 150 Half-round Effective cross-sectional area with 10mm freeboard: 6600mm² Install with minimum fall 1:500 to downpipes.

4. Gutters are to be fixed with powder coated aluminium brackets and snow straps at maximum 600¢

ROOFING LEGEND:




Pre-painted steel T-RIB profile roofing


dp


80mm Ø min downpipe.


Translucent T-RIB profile roofing




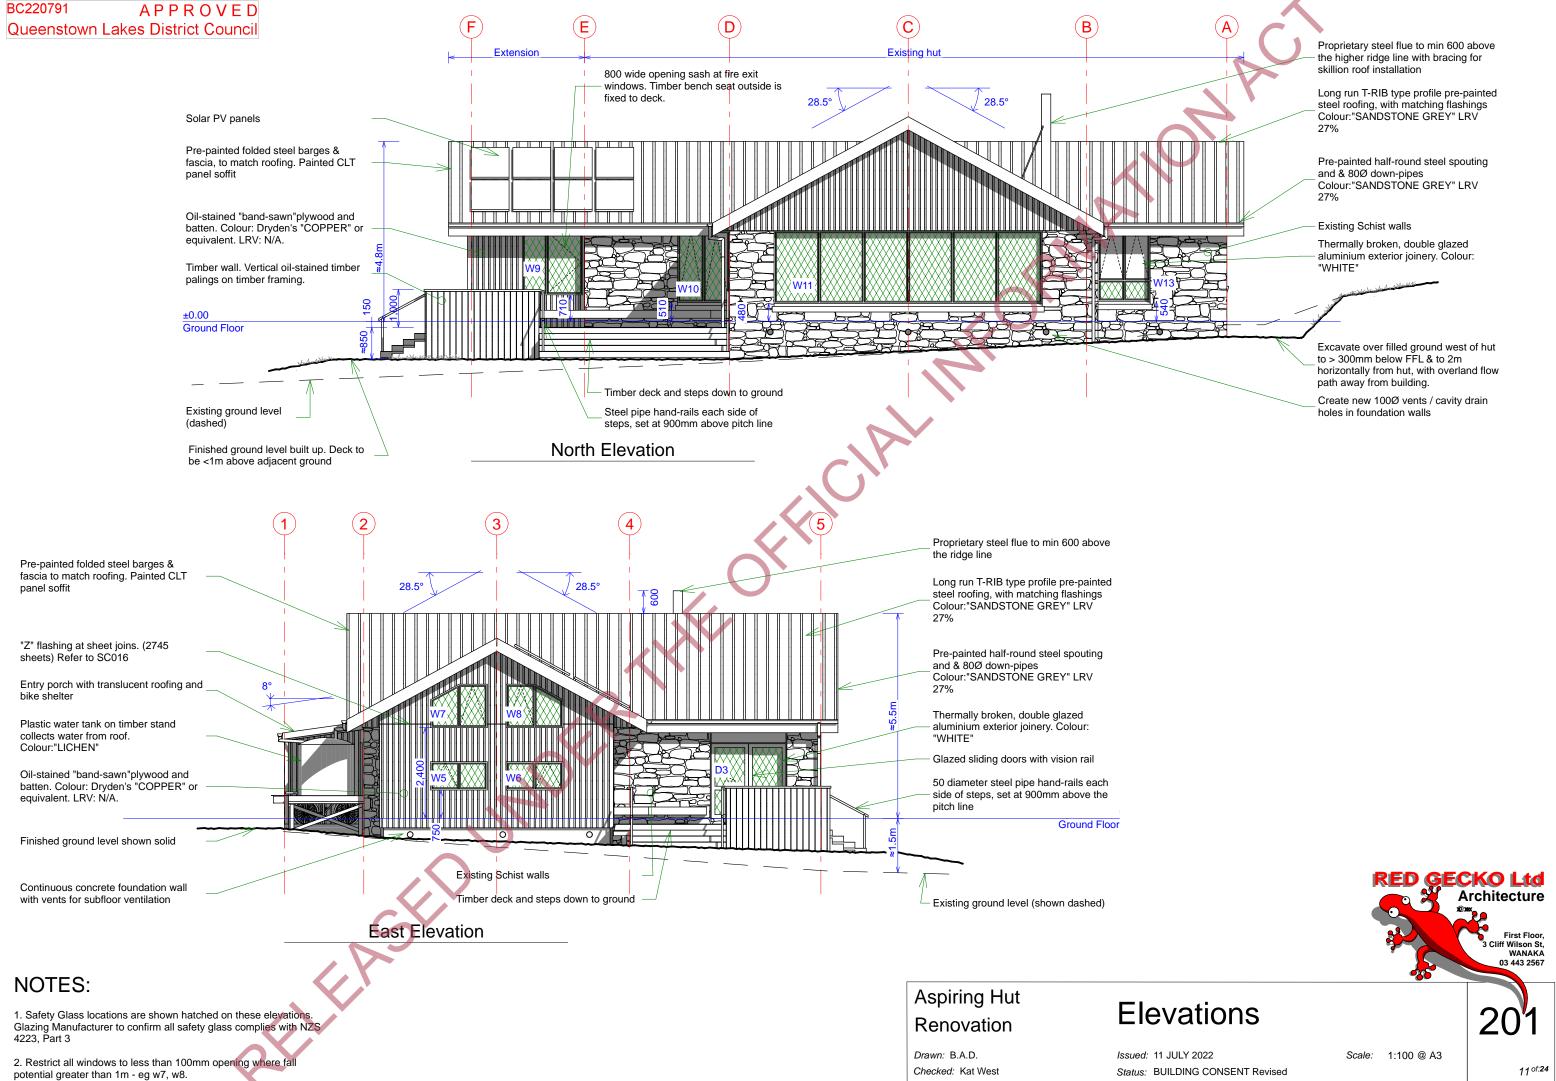


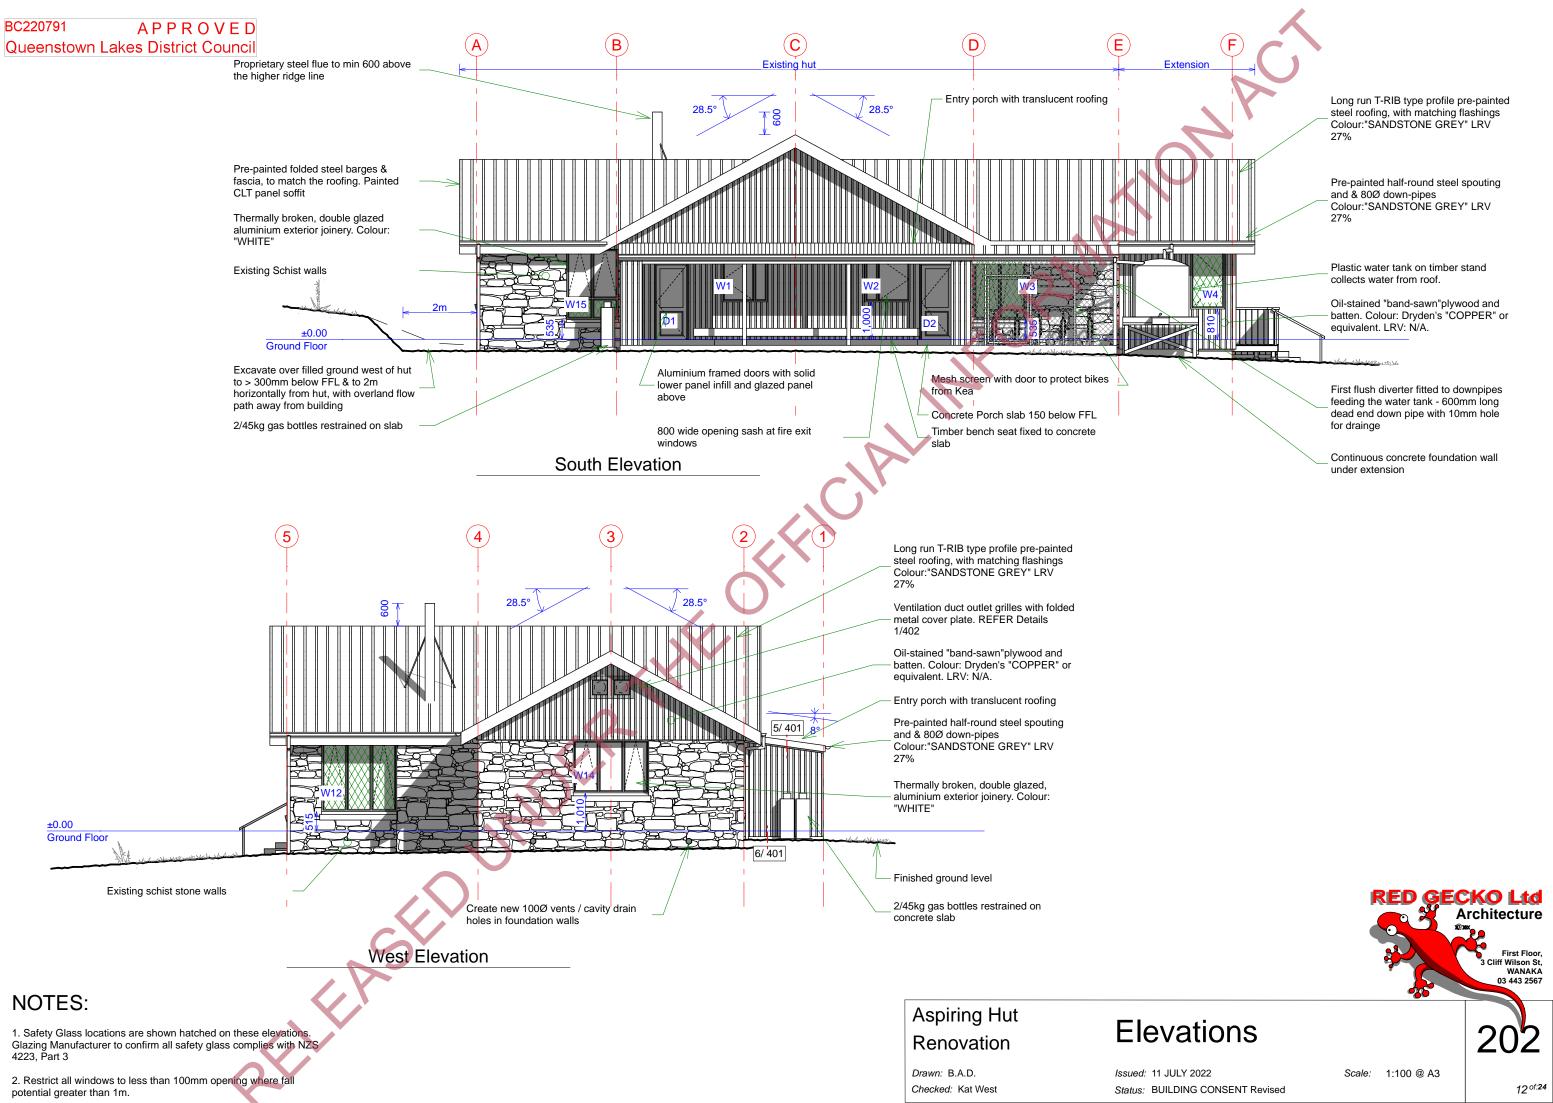

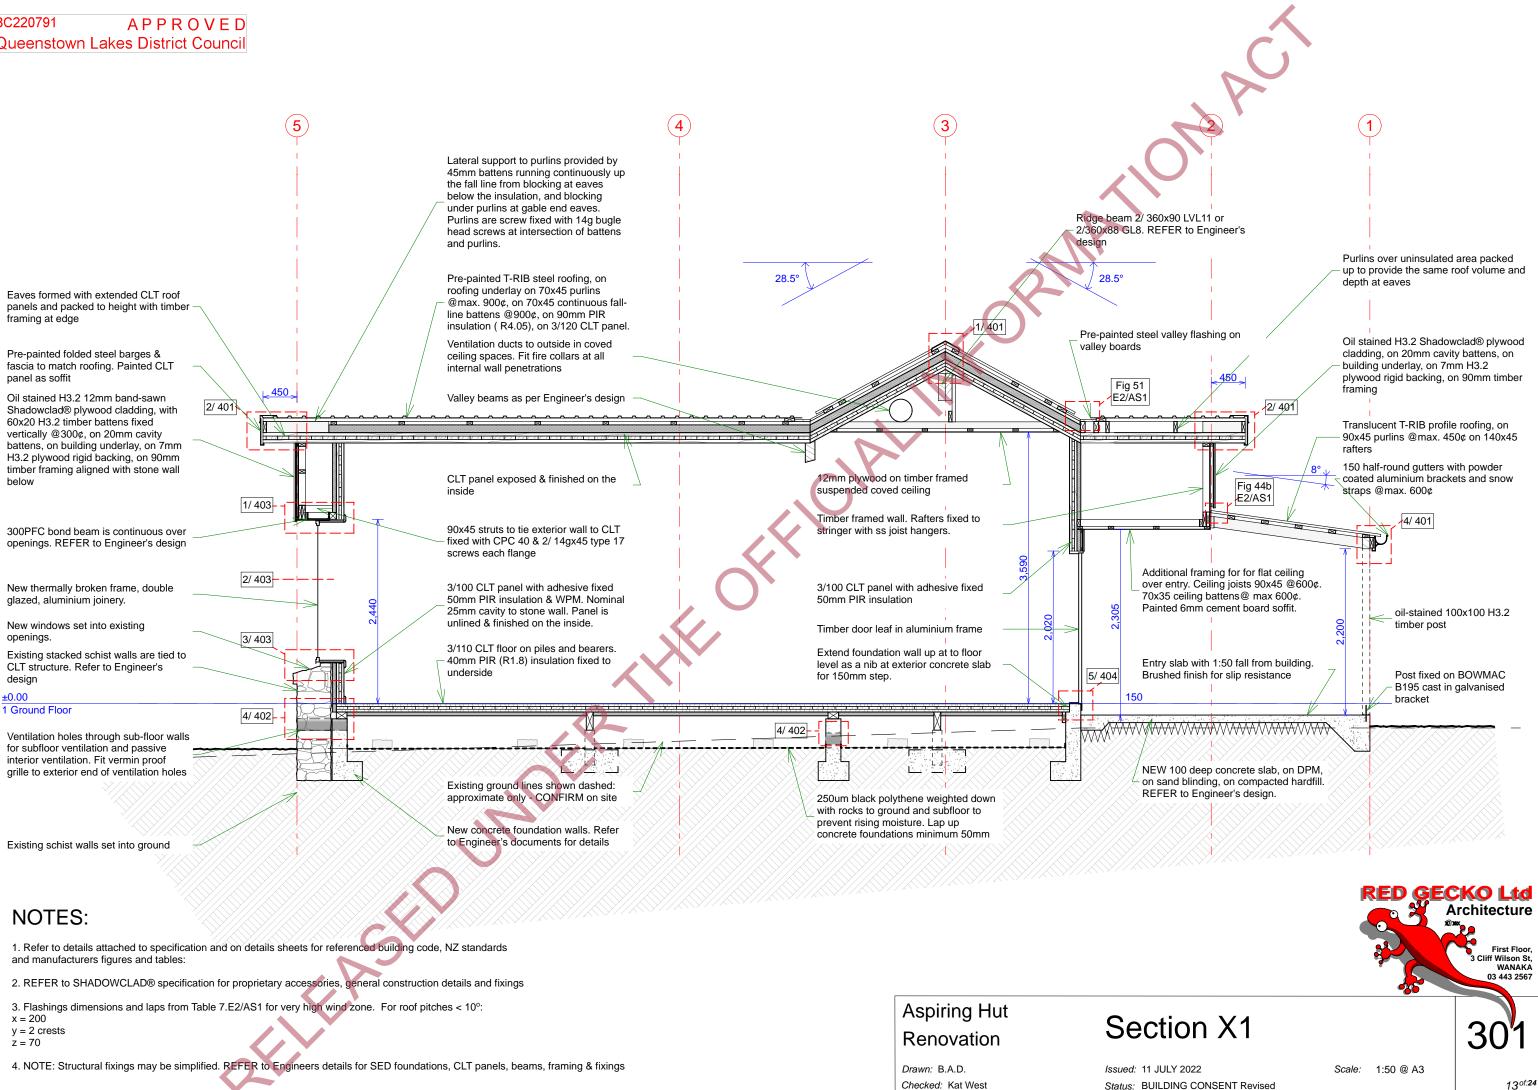

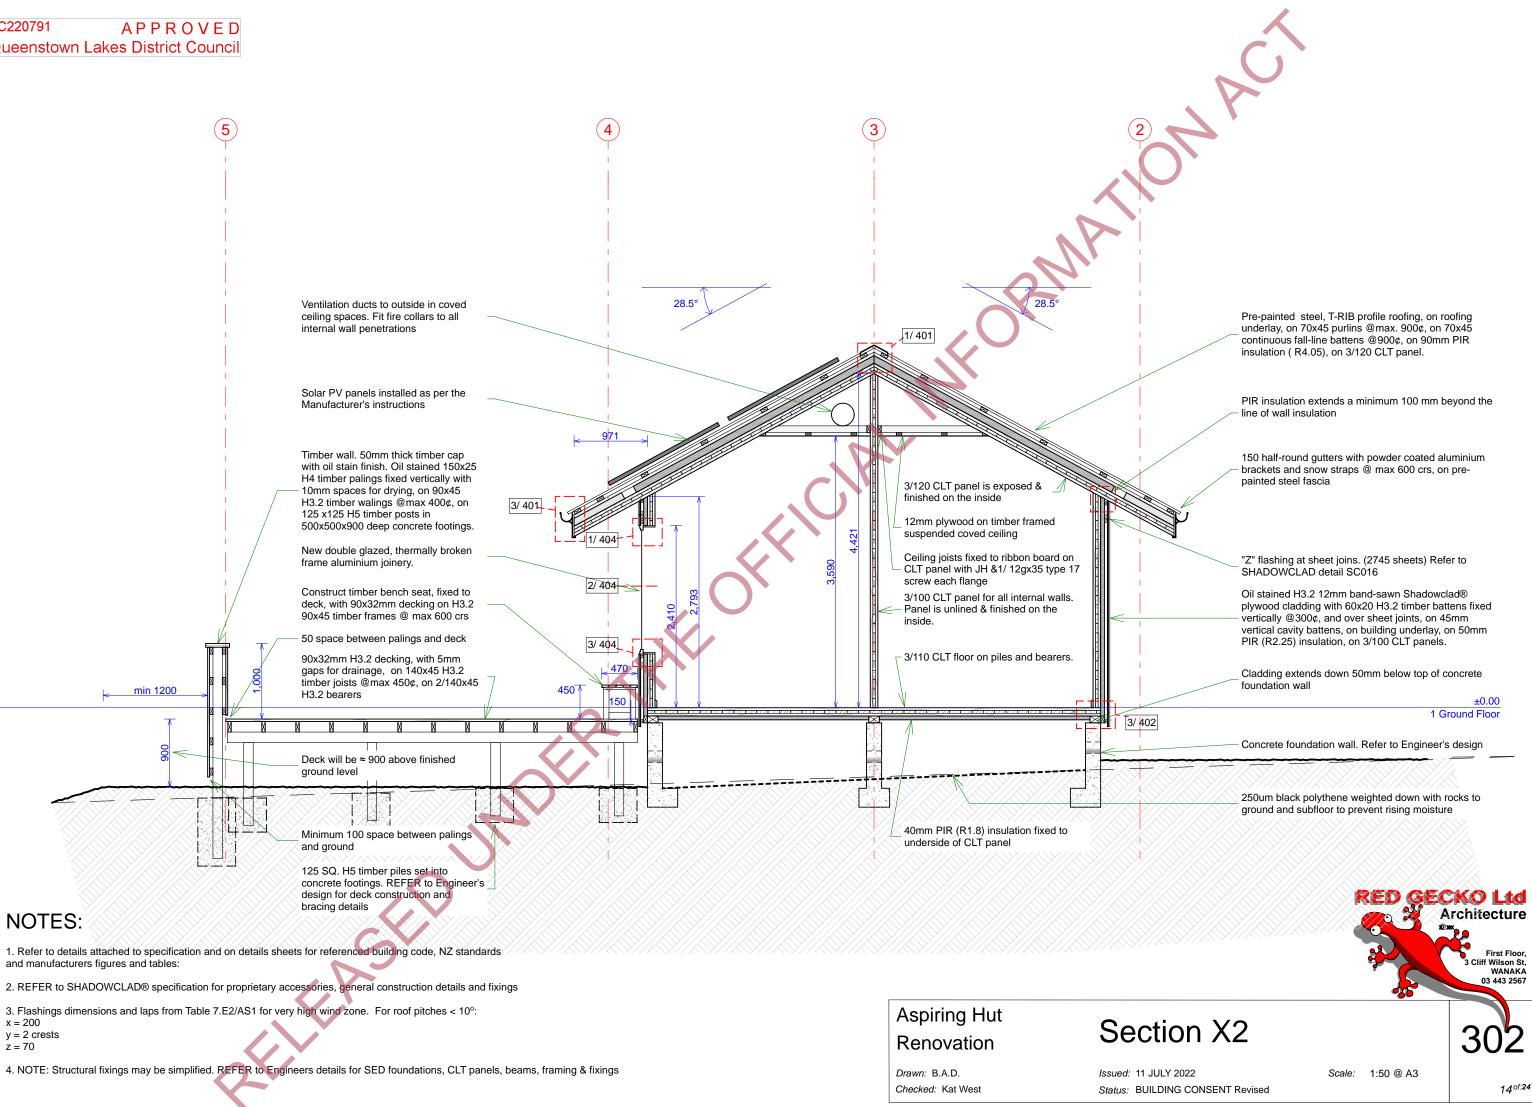

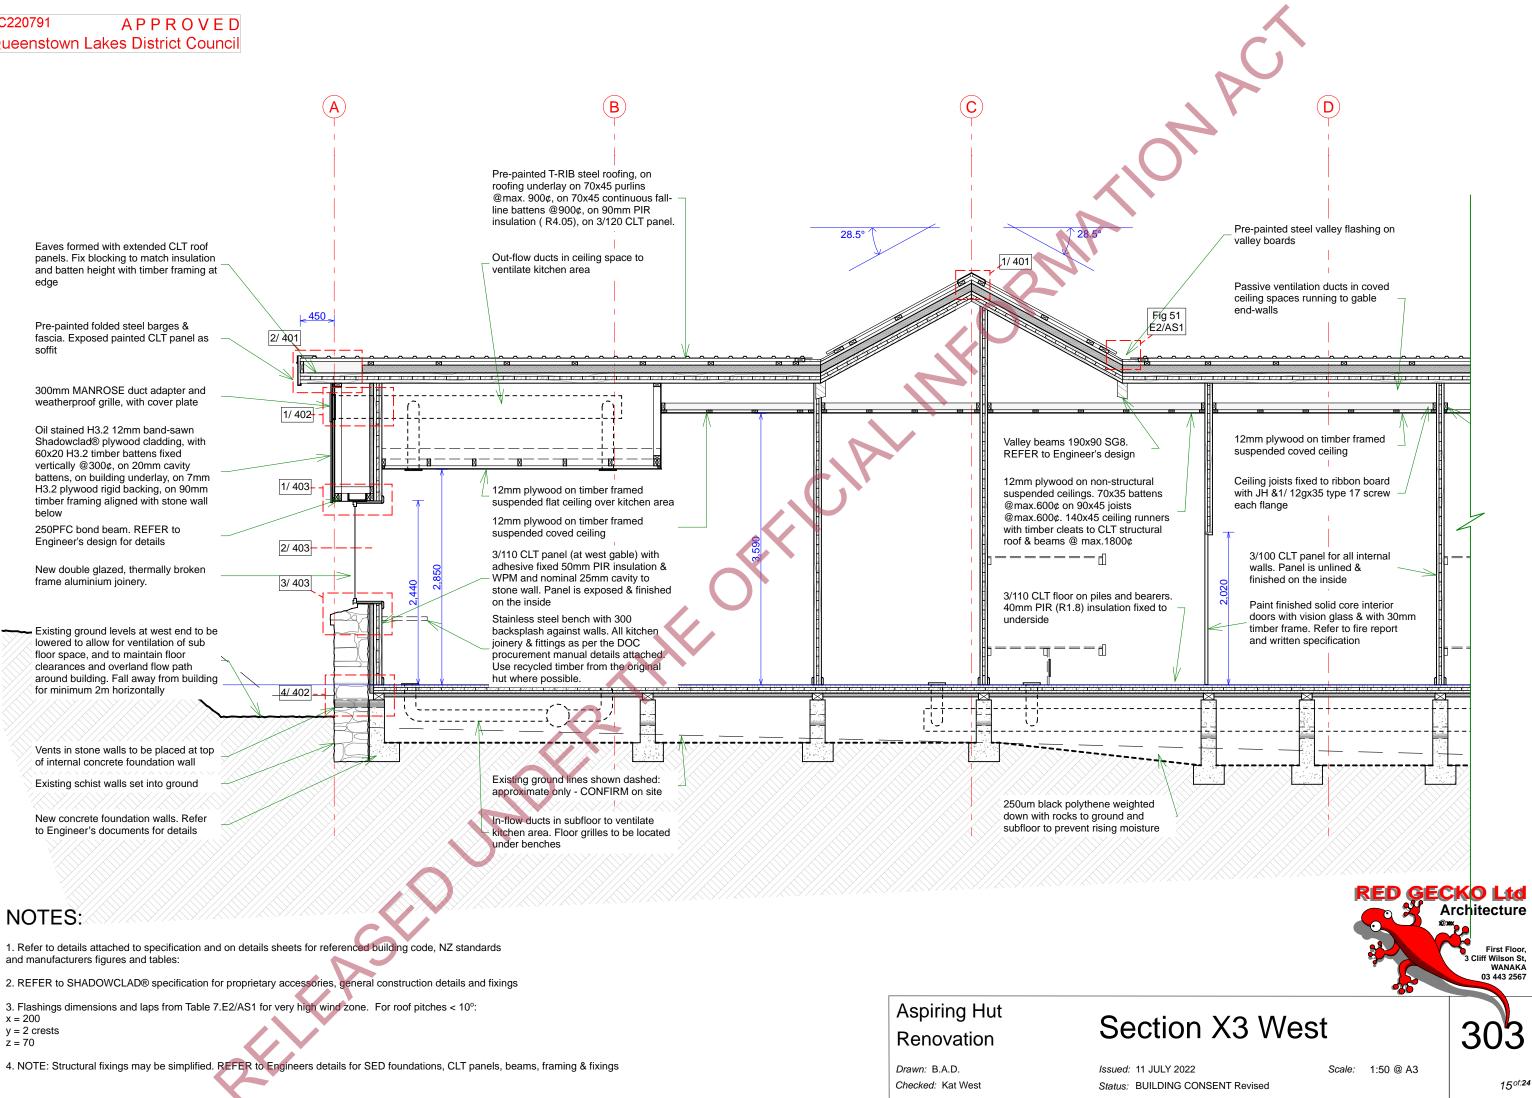

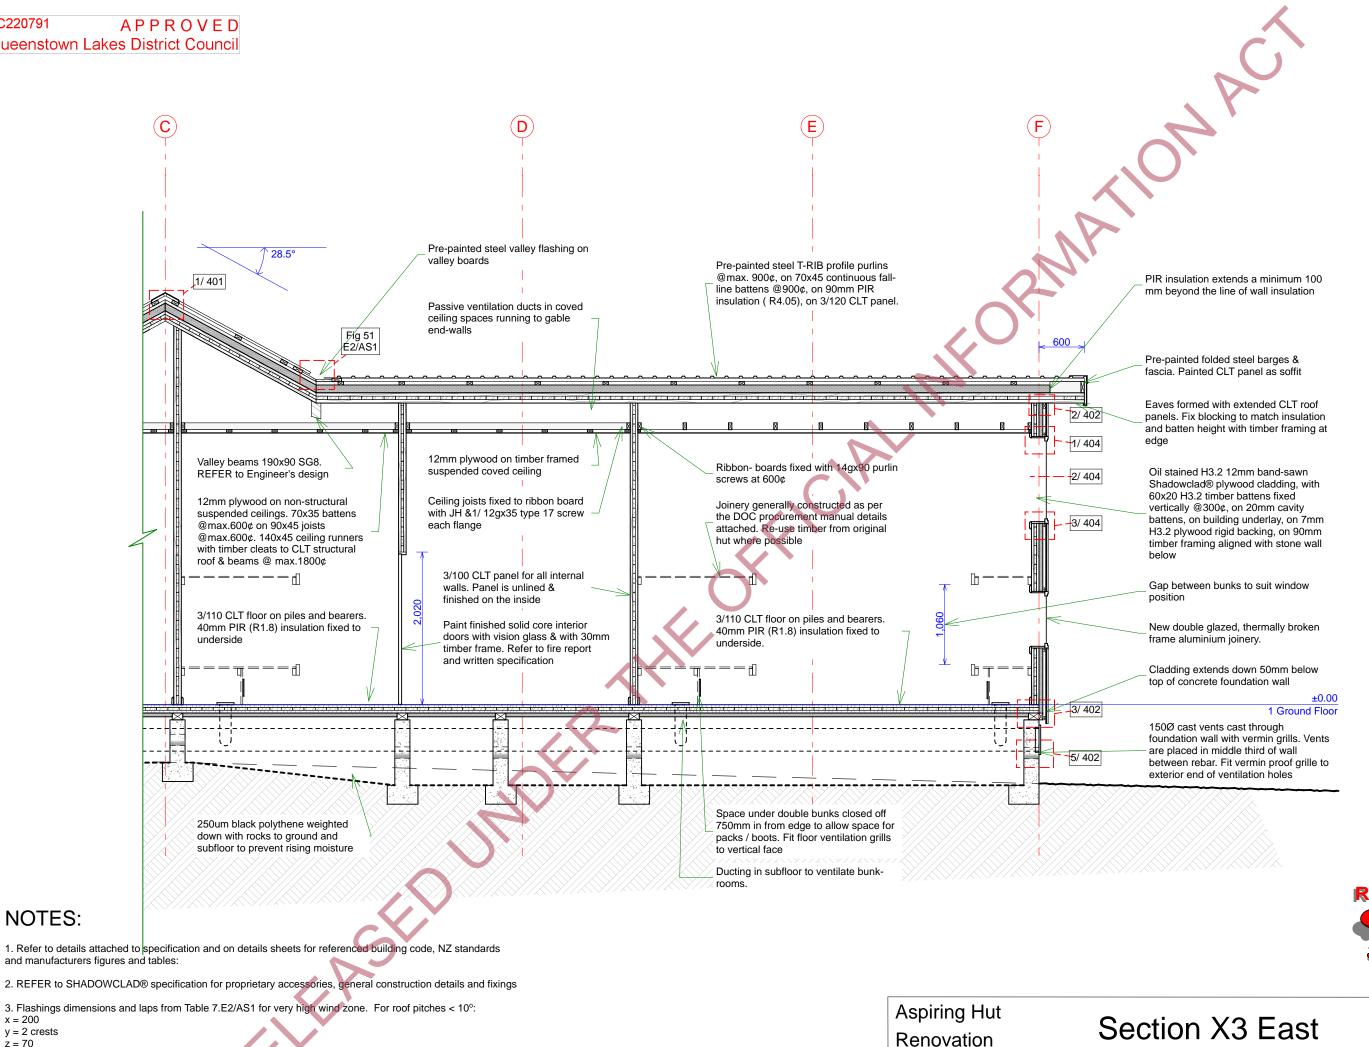

x = 200 y = 2 crests z = 70


NOTES:

4. NOTE: Structural fixings may be simplified. REFER to Engineers details for SED foundations, CLT panels, beams, framing & fixings

Drawn: B.A.D. Checked: Kat West Issued: 11 JULY 2022



1 Ground Floor

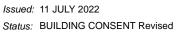




First Floor 3 Cliff Wilson St, WANAKA 03 443 2567

GECKO Ltd Architecture





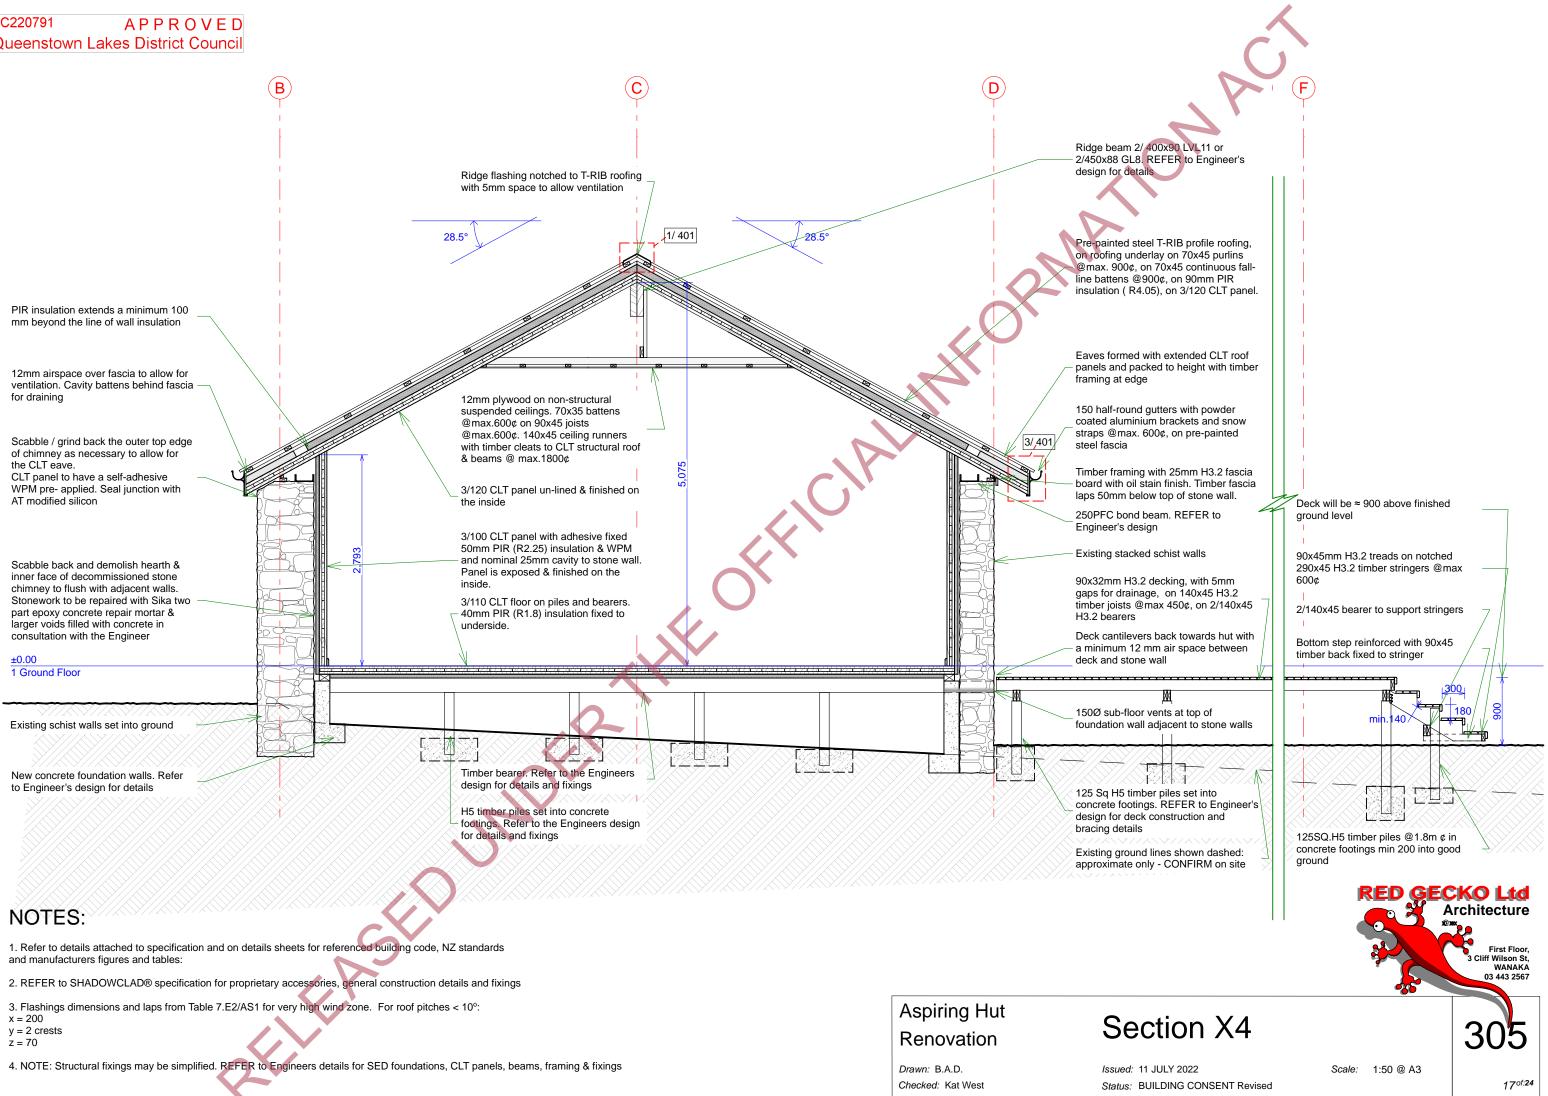



Timber purlins & fall- line battens fixed over continuous layer of PIR solid insulation. REFER to Engineer's documents for fixings

Fall line battens

ENERTHERM PIR solid insulation

Shaped packer. REFER to Engineer's design for details

Timber ridge beam. REFER to Engineer's design for details

Pre-painted, folded steel, barge flashings to suit roofing profile. Refer to E2/AS1 Fig47(b) with dimensions for very high wind zone given below

Pre-painted, custom folded steel barge, with centre swage for stiffness, over underlav

CLT panel is exposed as soffit. Paint finish.

Seal top of plywood rigid backing to CLT at top of wall with continuous bead of MS silicon

Timber batten at top of cladding, with chamfer to back corner

Shadowclad® plywood cladding, on 20mm vertical cavity battens

Pre-painted steel T-RIB profile roofing, on roofing underlay.

Drip edge eave flashing as per E2/AS1

Set lower edge purlin 12mm back from fascia, and provide 12mm gap to eave flashing for ventilation into roof space.

150 half-round gutters with powder coated aluminium brackets and snow straps @max. 600¢

Pre-painted folded steel fascia on 20mm cavity battens & DPC at 600¢ behind gutter brackets

Drill 6Ø holes in lower edge @600¢ for drainage

NOTES:

1. Refer to details attached to specification and on details sheets for referenced building code, NZ standards and manufacturers figures and tables.

Skillion roof

2 BARGE

50

35

3)

2. REFER to SHADOWCLAD® specification for proprietary accessories, general construction details and fixings

3. Flashings dimensions and laps from Table 7.E2/AS1 for very high wind zone. For roof pitches < 10°:

x = 200 y = 2 crests

z = 70 4. NOTE: Structural fixings may be simplified on these details. REFER to Engineers details for SED foundations, CLT panels, beams, framing & fixings

15

VENTED EAVE


1 VENTED RIDGE


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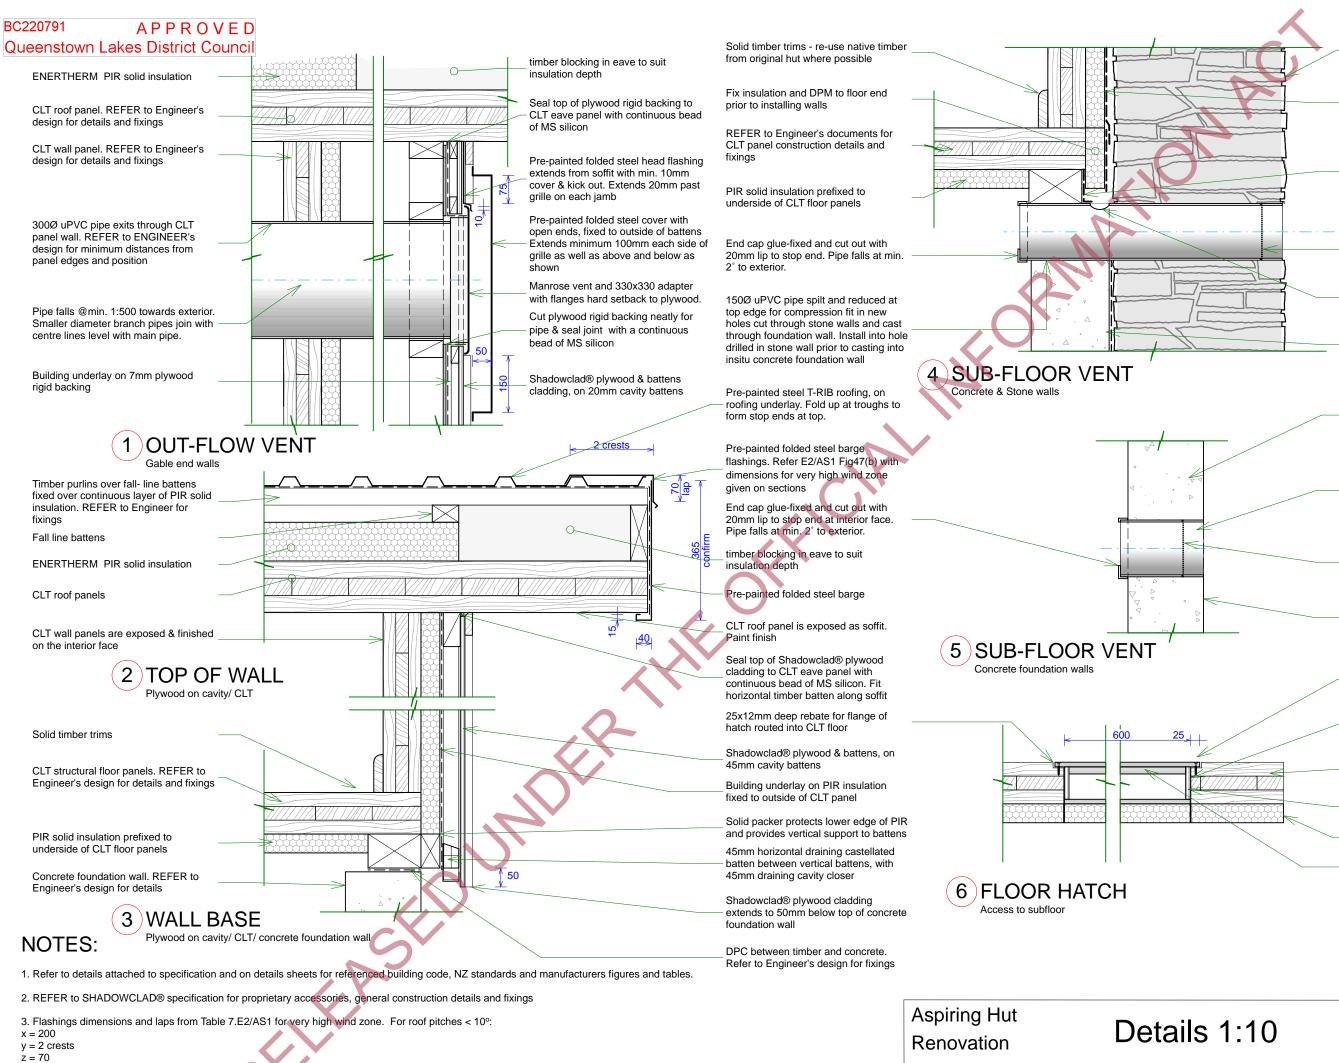




Detai

Drawn: B.A.D. Checked: Kat West Issued: 11 JULY Status: BUILDIN

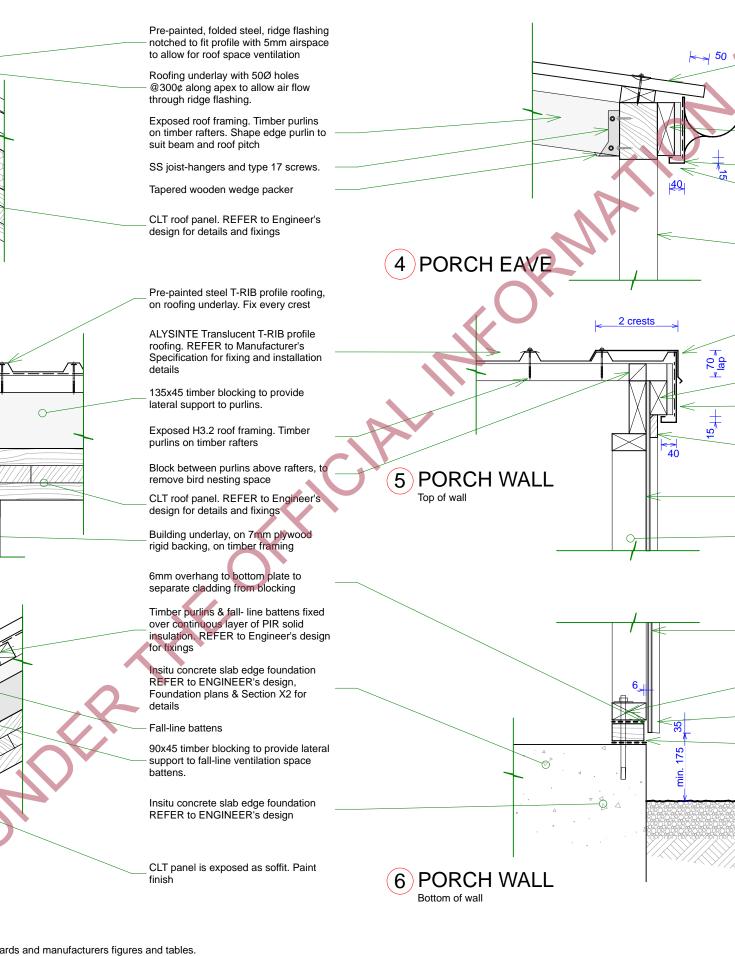X		
50	ALYSINTE Translucent T-RIB pro roofing. REFER to Manufacturer Specification for fixing and install details	s
	150 half-round gutters with powd coated aluminium brackets and s straps @max. 600¢	
- 175 Sonfirm	— 140x45 continuous timber packe	r
	Pre-painted folded steel fascia or 20mm cavity battens & DPC at 6 behind gutter brackets	
	Drill 6Ø holes in lower edge @60 drainage)0¢ for
	Oil-stained H3.2 timber beam & REFER to Roof Framing Plan & Engineer's design for details	oost.
_	Pre-painted folded steel barge fla — as per E2/AS1 Fig47(b) with dimensions for very high wind zo	Ū
	— 90x45 timber packer	
5++	Pre-painted custom folded steel — on DPC, on 20mm cavity battens 600¢	
~	Continuous Shadowclad® batter of wall	i to top
	Shadowclad® plywood & battens fixed on timber framing.	direct
	90mm H3.2 timber wall framing is exposed on interior side	S
_	Shadowclad® plywood & battens fixed on timber framing. SS approved bottom plate ancho @max. 900¢	
	Cladding extends 35mm over bo	ttom
-	Ex 90x45 H5 blocks as packers a bottom plate fixing, with DPC abo and below	
	Ground slopes away from buildin 1m.	ıg min.
<	— min 100 deep clean free draining	ı gravel
		First Floor, WANAKA 03 443 2567
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4. NOTE: Structural fixings may be simplified on these details. REFER to Engineers details for SED foundations, CLT panels, beams, framing & fixings

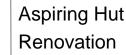Drawn: B.A.D. Checked: Kat West Issued: 11 JULY 2022 Status: BUILDING CONSENT Revised Existing stone walls. REFER to Engineer's design.

PIR insulation and peel and stick DPM adhesive fixed to CLT panel prior to installation. Provide additional length to lap down over floor end DPM as shown

Apply 2 coats of bitumous DPC & peel and stick DPM to face of plate and base of channel (along full length of foundation wall to protect from moisture in cavity)

6mm square holes galvanised steel mesh vermin screen fitted between two sections of pipe.

Drill a 50Ø hole in top of vent pipe to allow for drainage from cavity

Concrete foundation wall., with DPM on outside face. REFER to Engineer's design for details

Concrete foundation wall. REFER to Engineer's design for details

150Ø uPVC pipe cast through foundation wall. Pipe set in middle third of wall for interior walls, and at top of wall where it is adjacent to stone cladding (to additionally act as drain for cavity) REFER to ENGINEER's details.

6mm square hole galvanised steel mesh vermin screen fitted between two sections of pipe

Exterior face of wall. NOTE - Detail similar for interior foundation wall vents however vermin mesh not required

10gx 45 ss screws in 25mm flange & 300¢ to all sides of opening. Partially back screws out and use as lifting points to open hatch

Coat cut faces of CLT panel and plywood with three coats of flooring urethane to seal completely

CLT floor panel. REFER to Engineer's design for details and fixings

Screwed & glued plywood box to fit 600x600 cut out hole


PIR solid insulation prefixed to underside of CLT floor panels

Additional 12mm plywood fully glued to upper 12mm flooring plywood





Scale: 1:10 @ A3

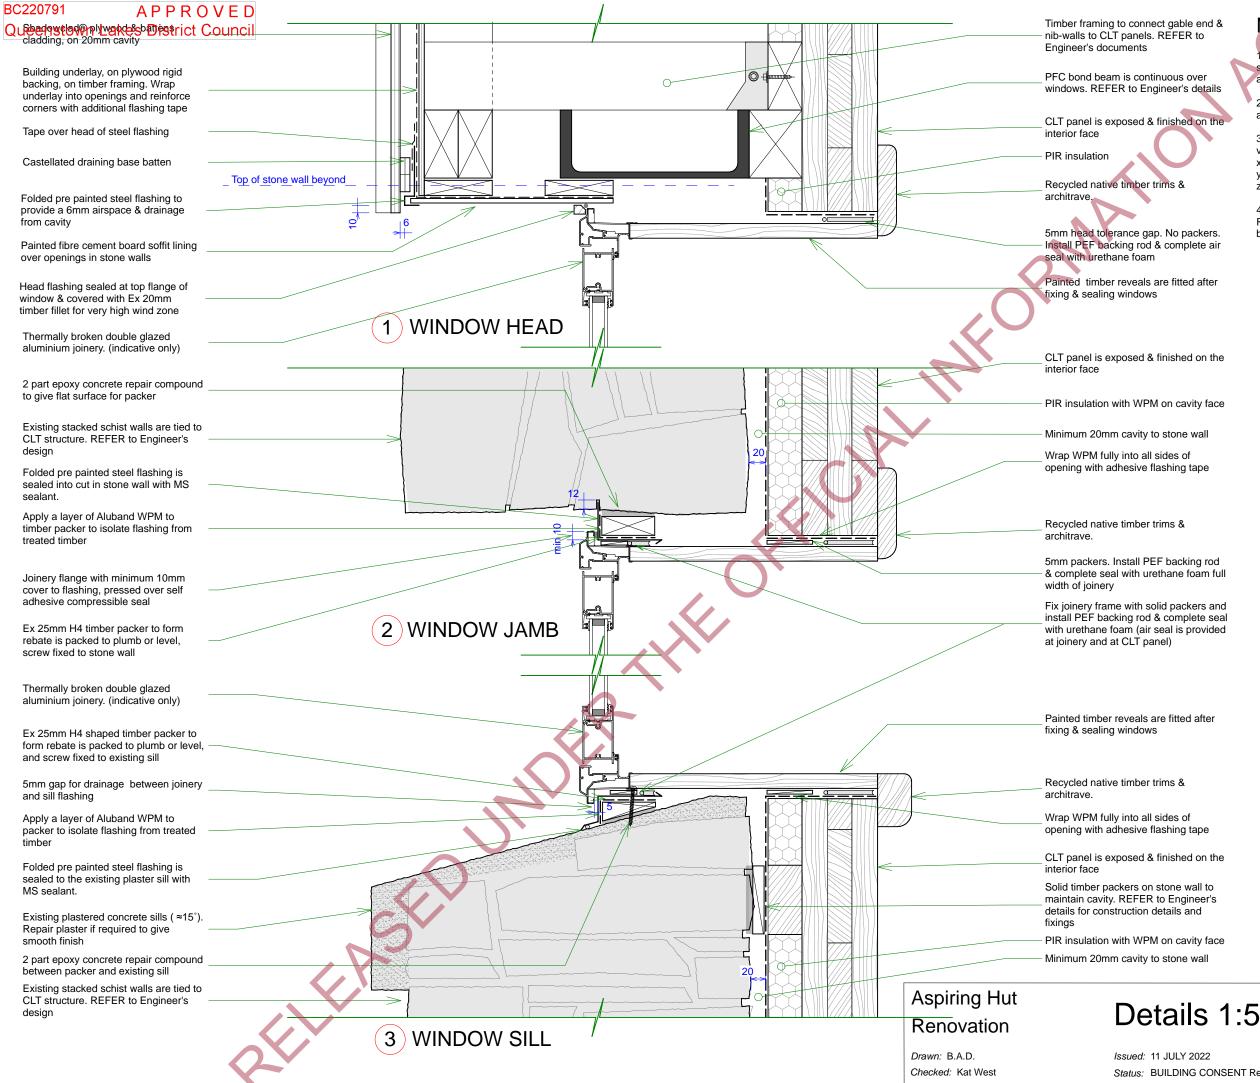

Status: BUILDING CONSENT Revised



Refer to details attached to specification and on details sheets for referenced building code, NZ standards and manufacturers figures and tables

2. REFER to SHADOWCLAD® specification for proprietary accessories, general construction details and fixings

3. Flashings dimensions and laps from Table 7.E2/AS1 for very high wind zone. For roof pitches $< 10^{\circ}$: x = 200 y = 2 crests z = 70

4. NOTE: Structural fixings may be simplified on these details. REFER to Engineers details for SED foundations, CLT panels, beams, framing & fixings




First Floor 3 Cliff Wilson St, WANAKA 03 443 2567

GECKO Ltd


Architecture



20^{of:24}

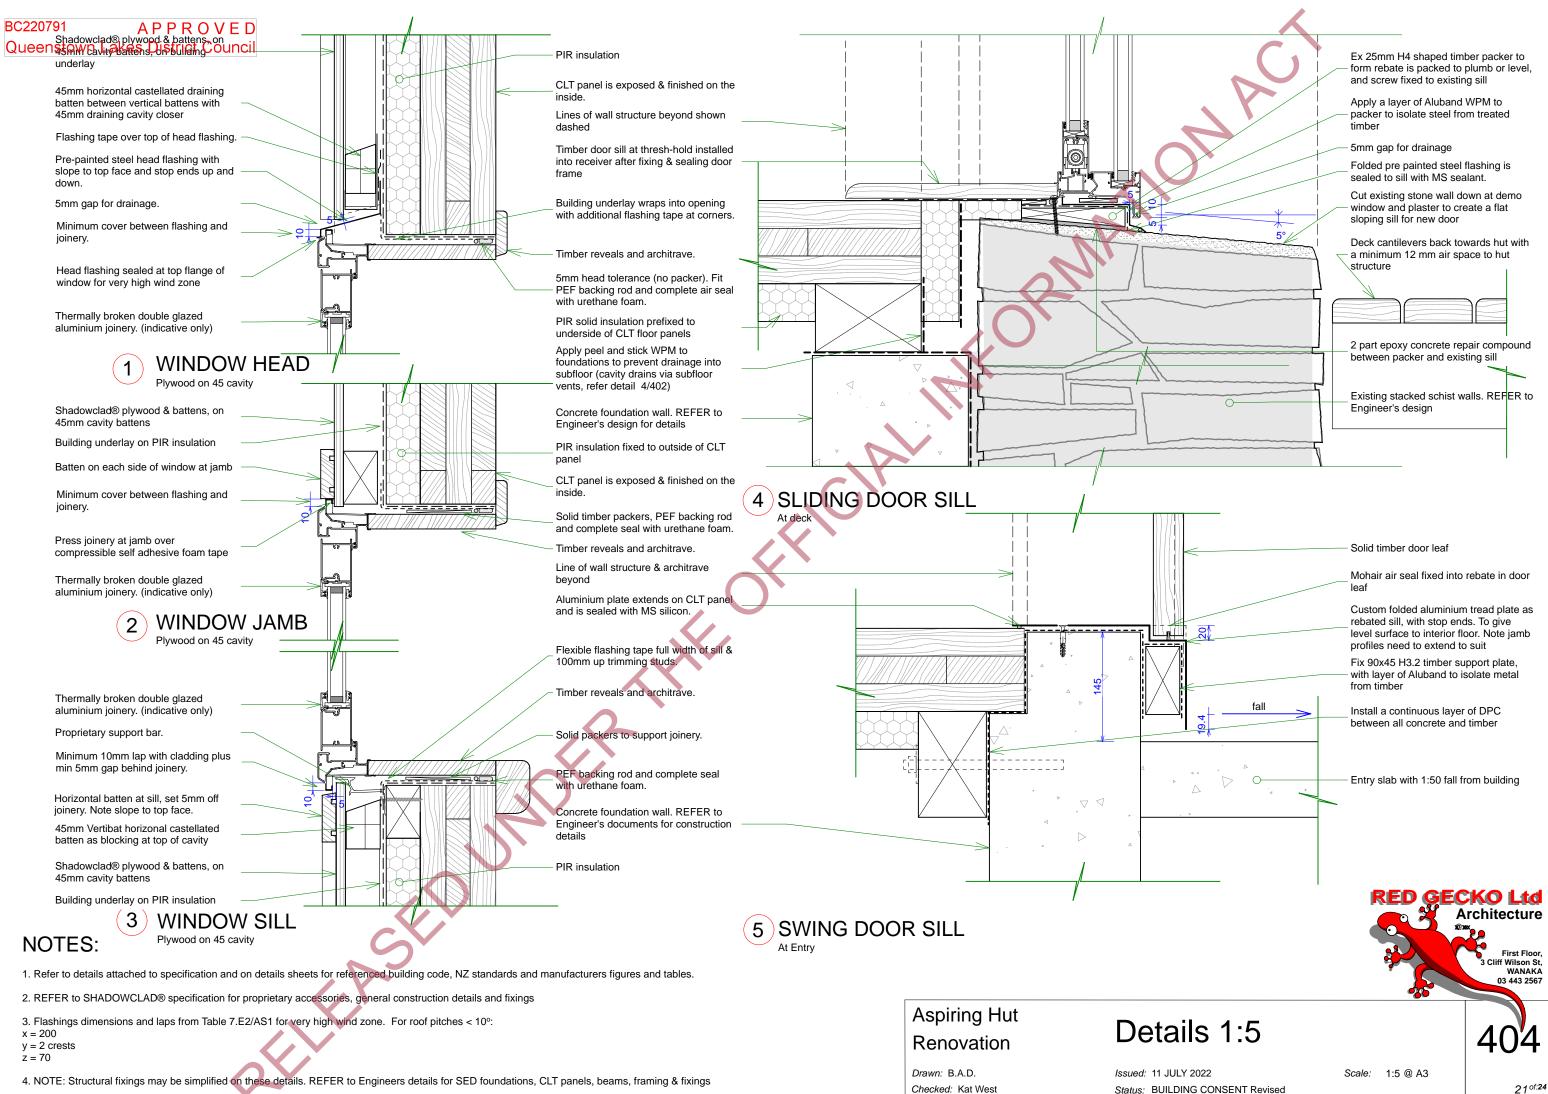

Checked: Kat West

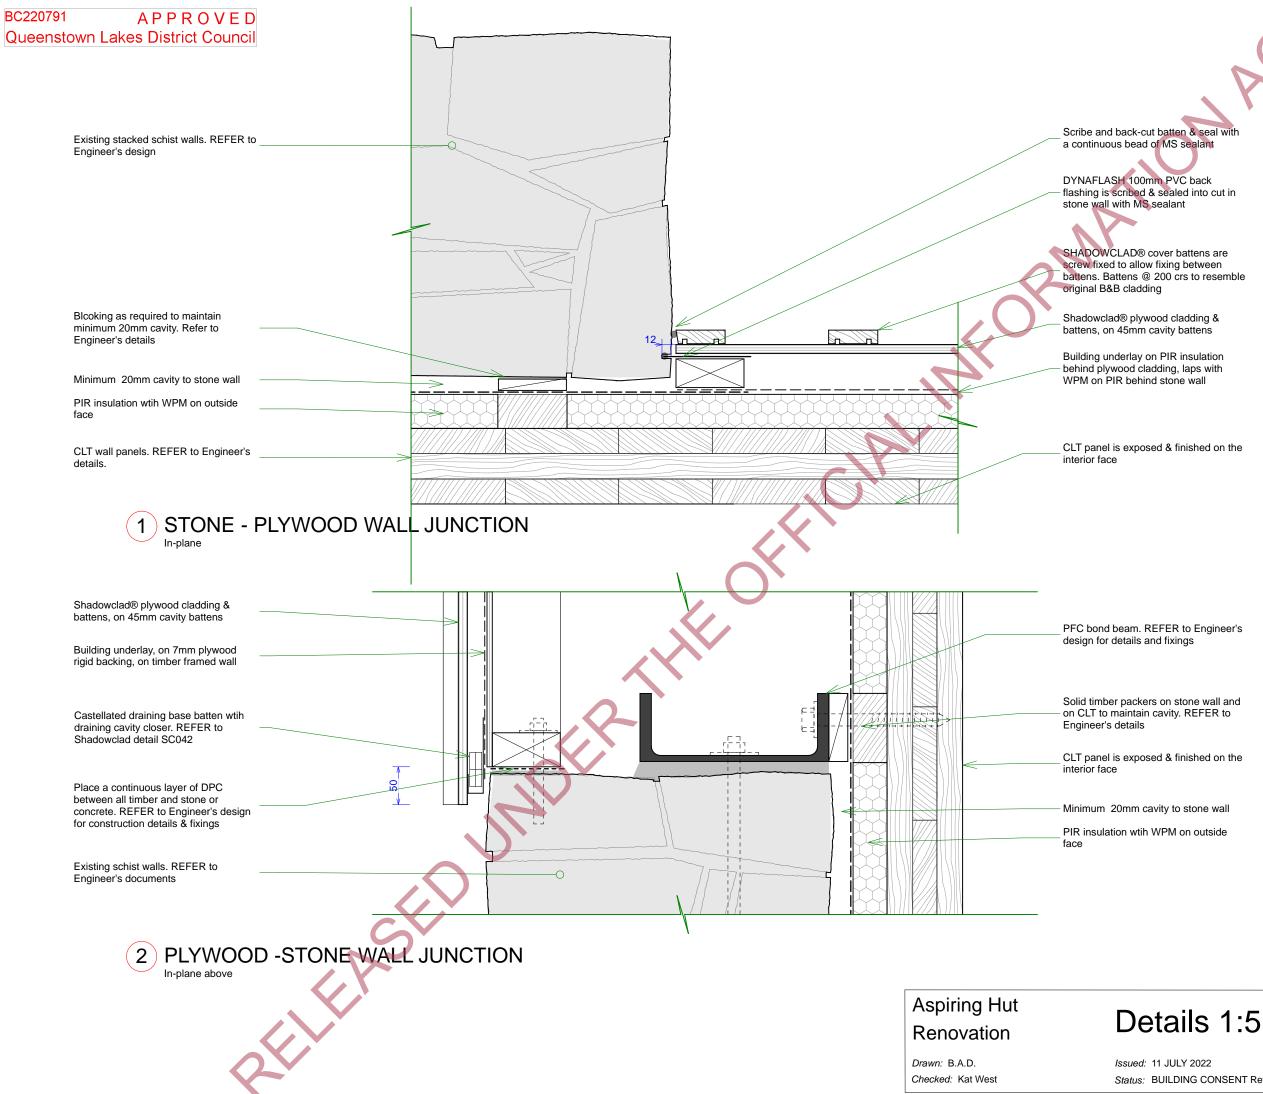



1. Refer to details attached to specification and on details sheets for referenced building code, NZ standards and manufacturers figures and tables:

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3. Flashings dimensions and laps from Table 7.E2/AS1 for very high wind zone. For roof pitches $< 10^{\circ}$: x = 200 y = 2 crests z = 70

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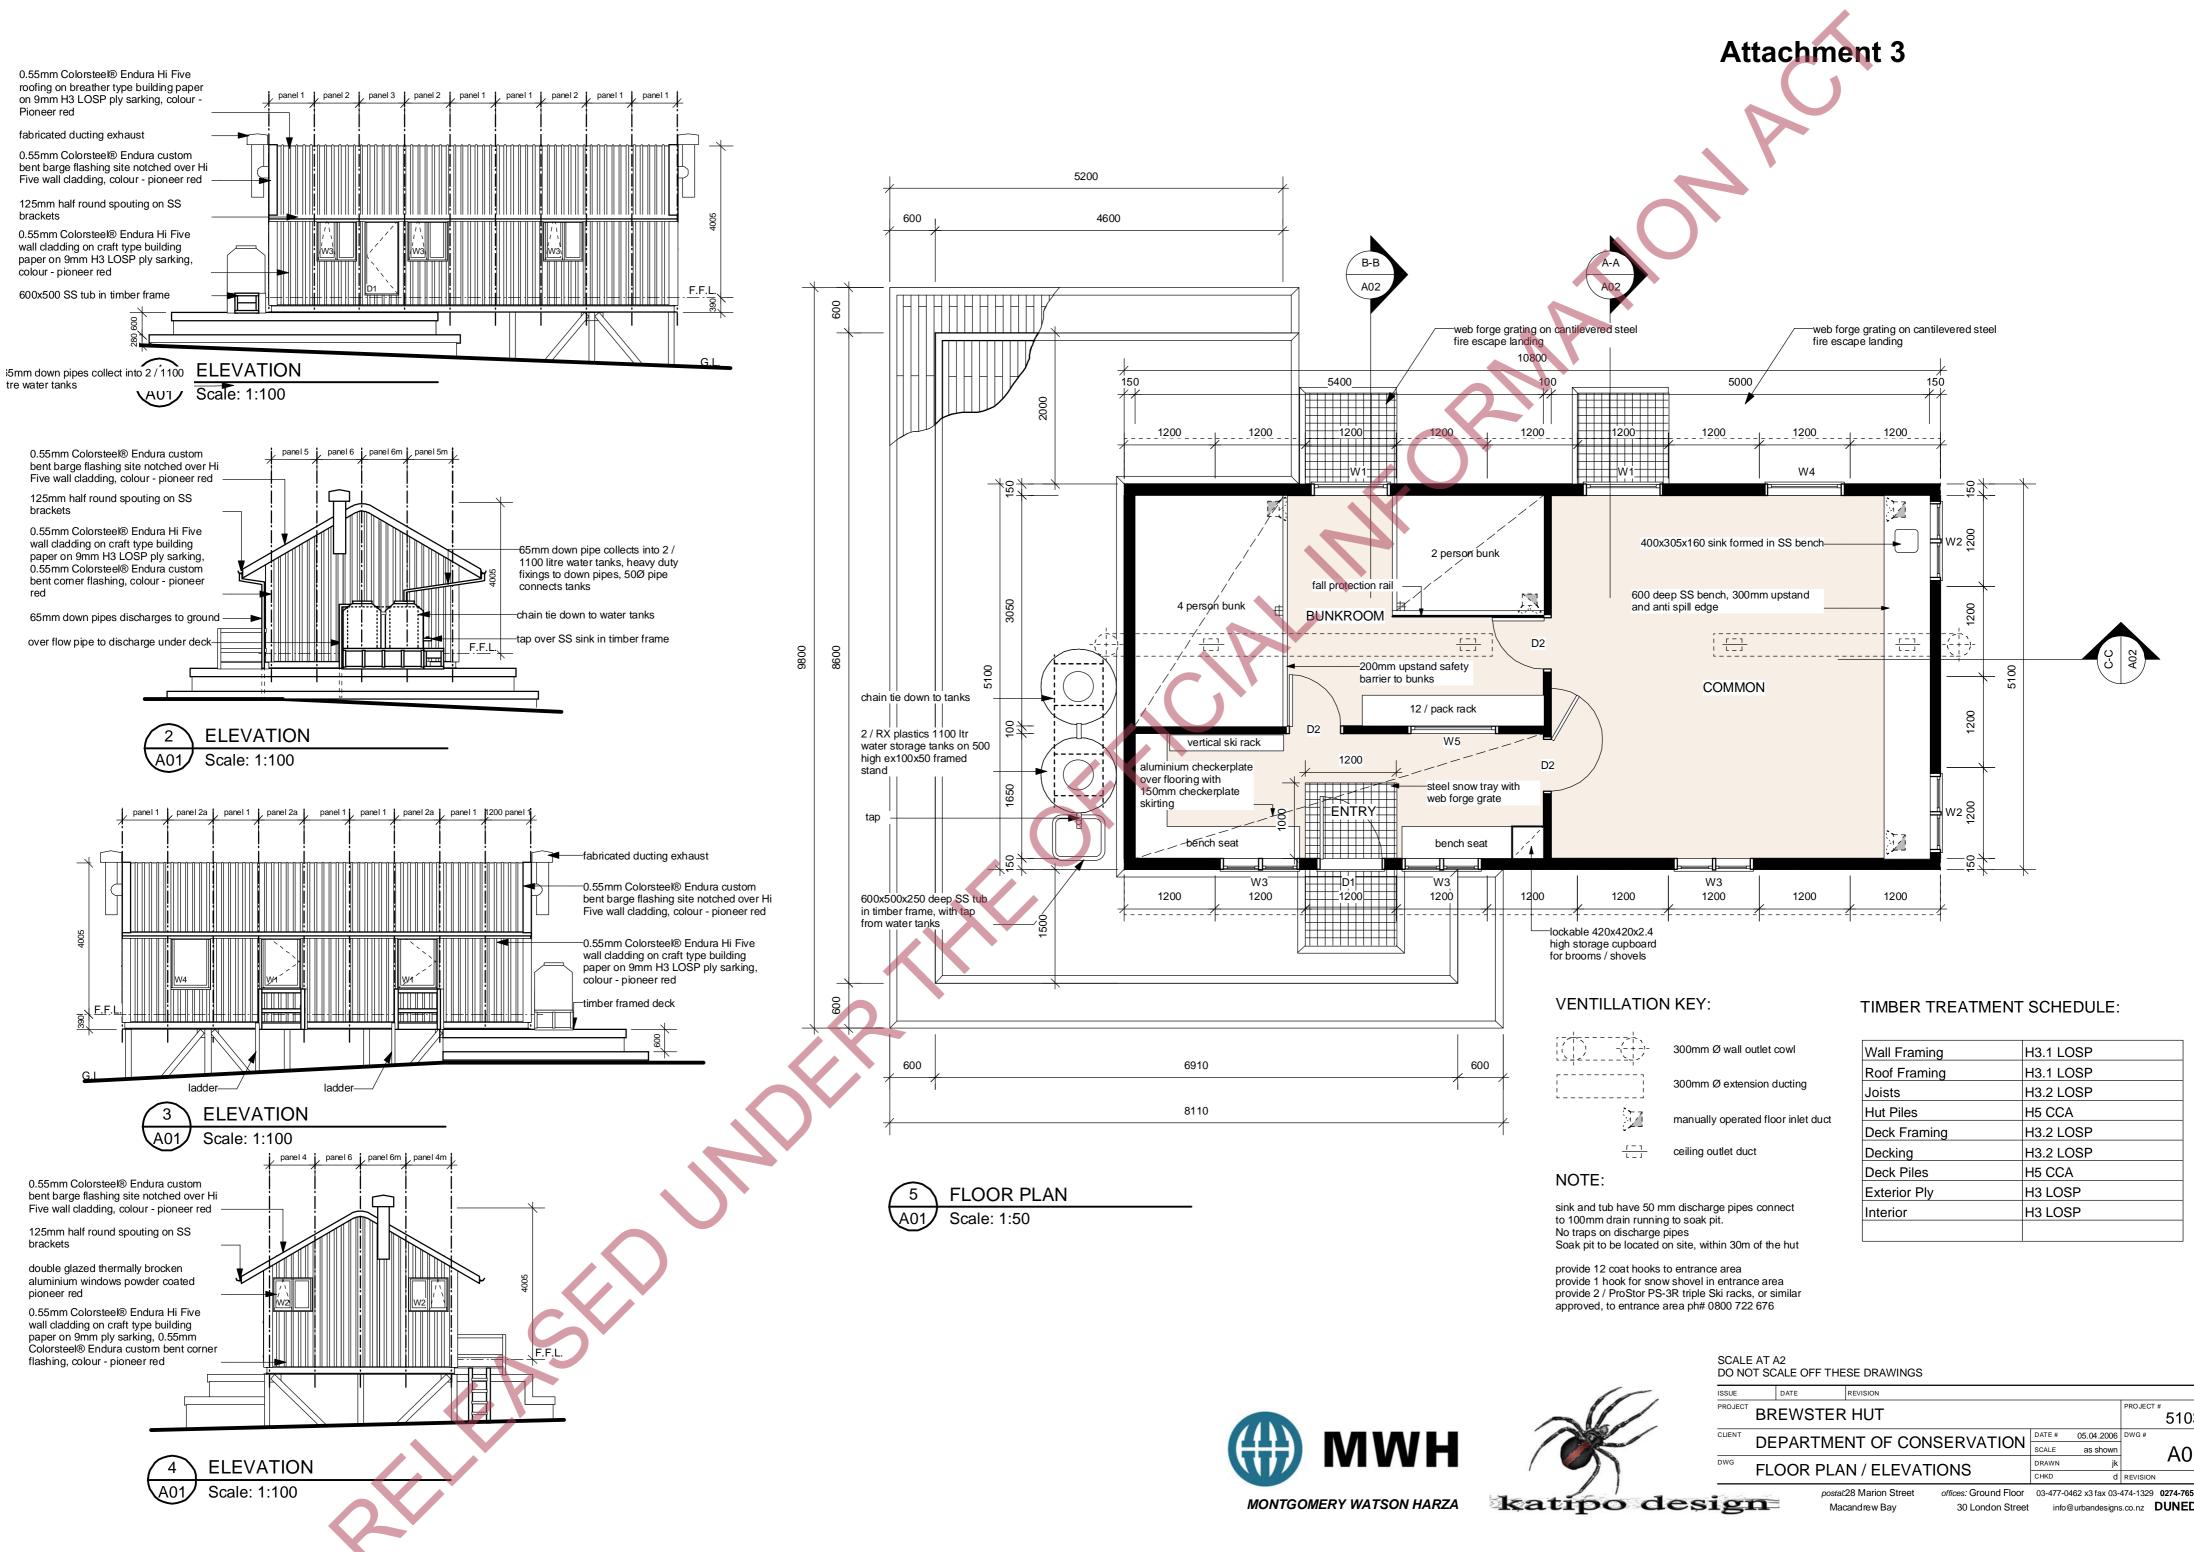


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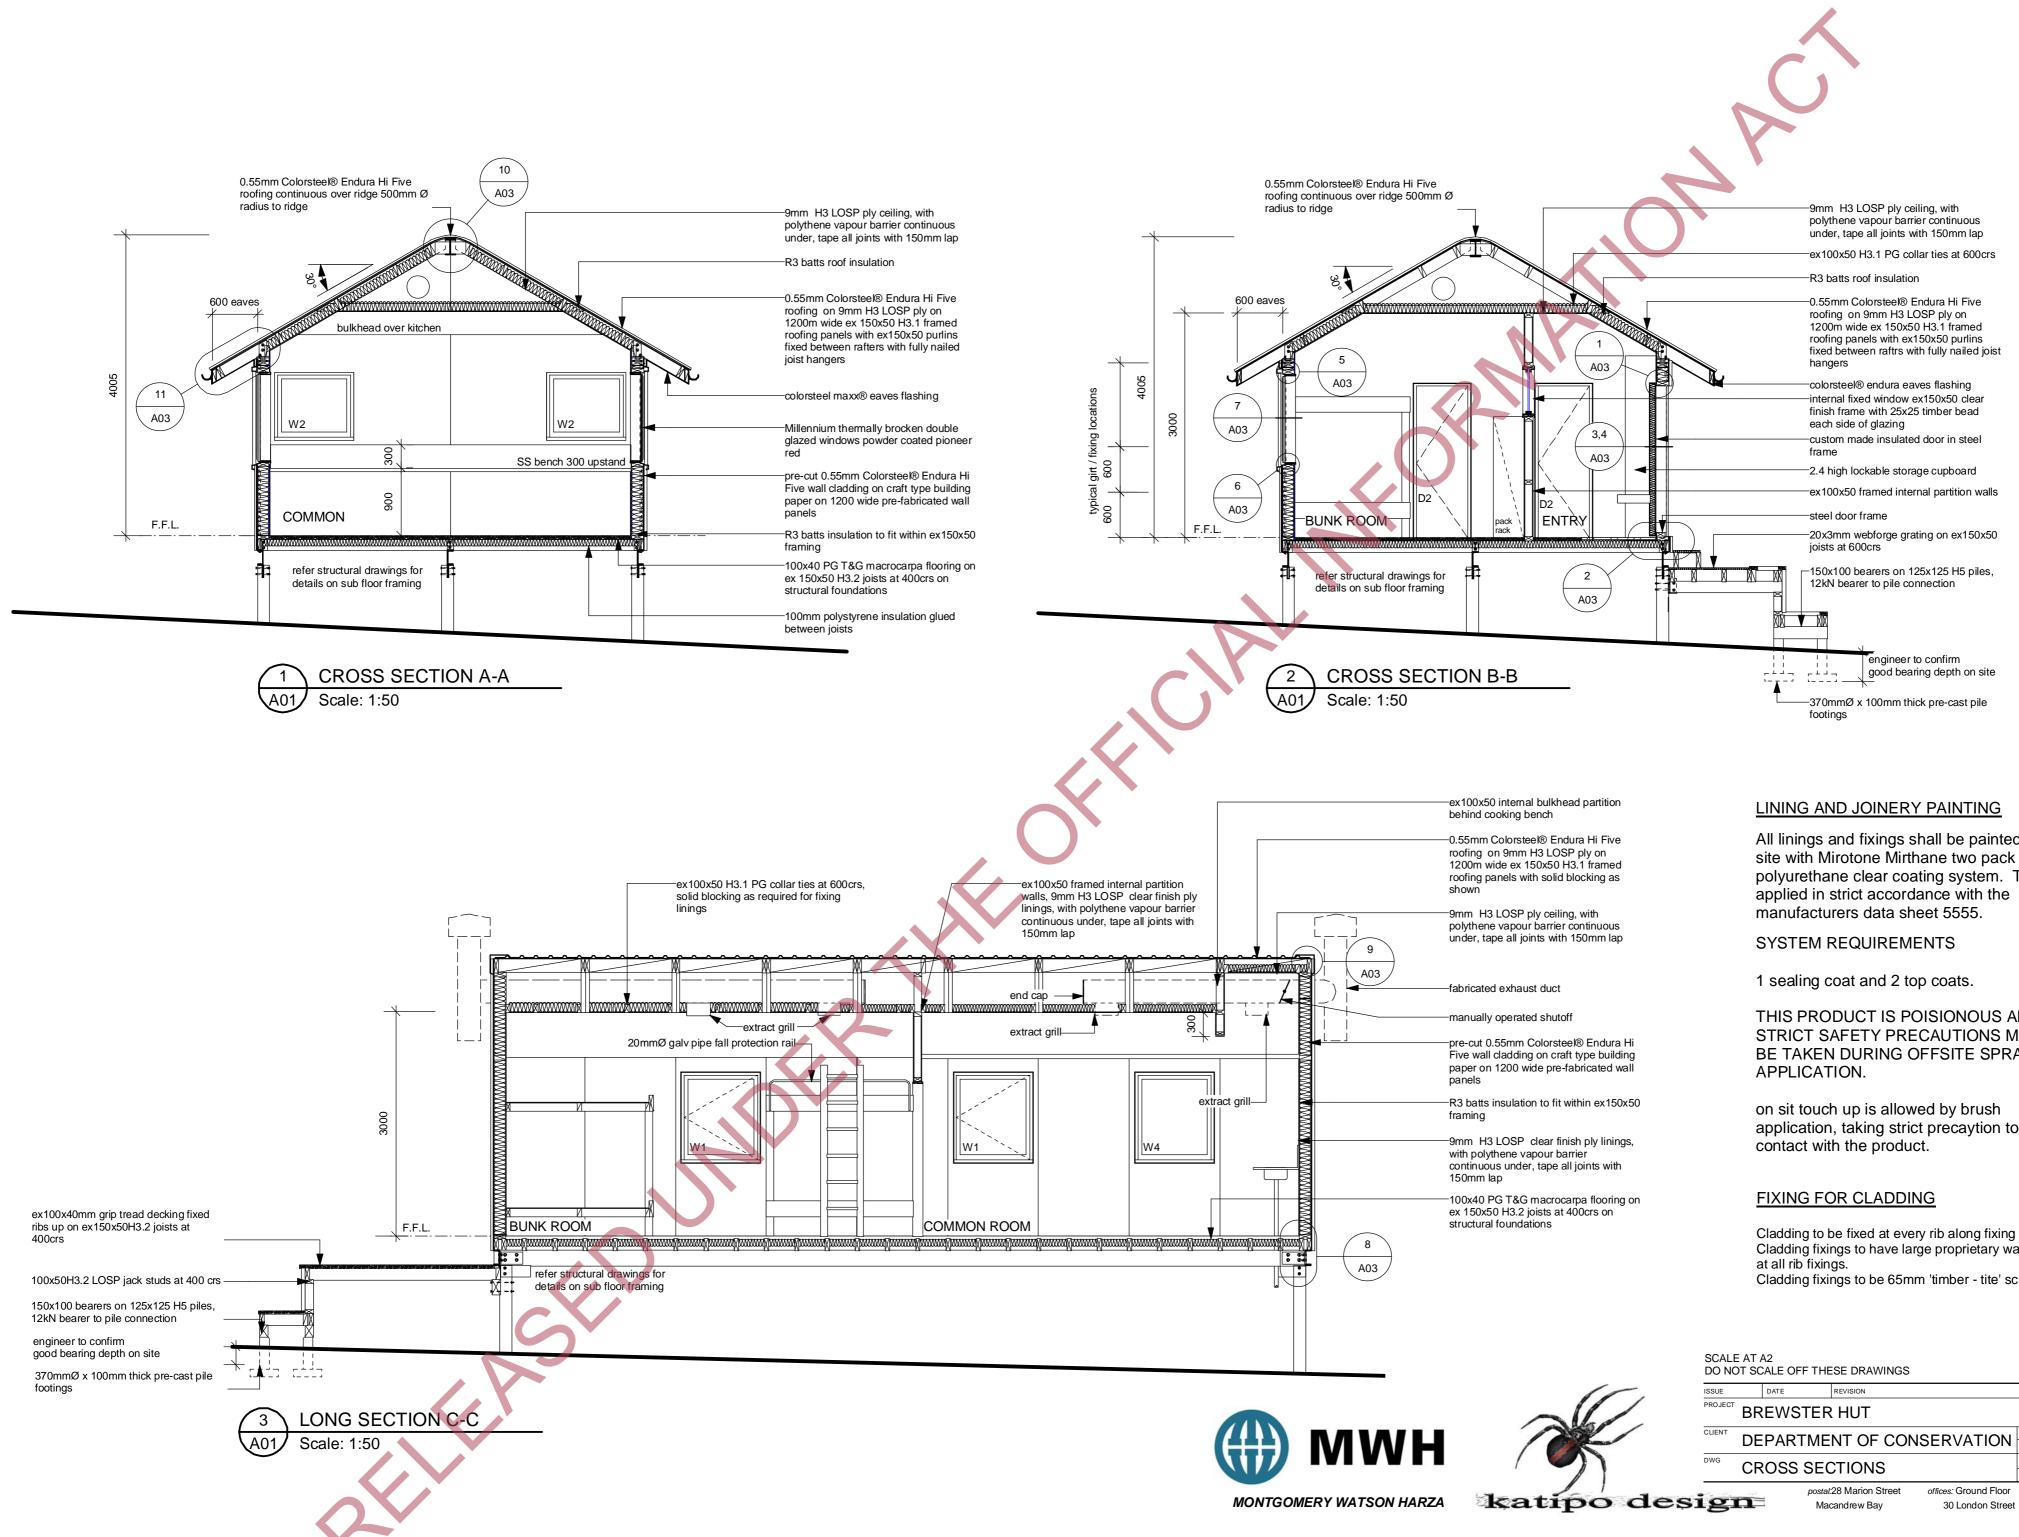
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ISSUE		DATE	REVISION					
PROJECT	BR	EWSTER	HUT				PROJECT	[#] 5103
CLIENT	DEPARTMENT OF CONSERVATION				DATE #	05.04.2006	DWG #	
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DWG	FLOOR PLAN / ELEVATIONS			DRAWN	jk		AU I	
	FLOOR PLAN / ELEVATIONS				CHKD	d	REVISION	
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121	n	E Mao	candrew Bay	30 London Street	info	@urbandesigns	s.co.nz	DUNEDIN



All linings and fixings shall be painted off site with Mirotone Mirthane two pack polyurethane clear coating system. To be


THIS PRODUCT IS POISIONOUS AND STRICT SAFETY PRECAUTIONS MUST BE TAKEN DURING OFFSITE SPRAY


application, taking strict precaytion to avoid


Cladding to be fixed at every rib along fixing lines. Cladding fixings to have large proprietary washers Cladding fixings to be 65mm 'timber - tite' screws


5103 DATE # 06.04.2006 DWG # DEPARTMENT OF CONSERVATION SCALE -A02

offices: Ground Floor 03-477-0462 x3 fax 03-474-1329 0274-765-205 30 London Street info@urbandesigns.co.nz DUNEDIN

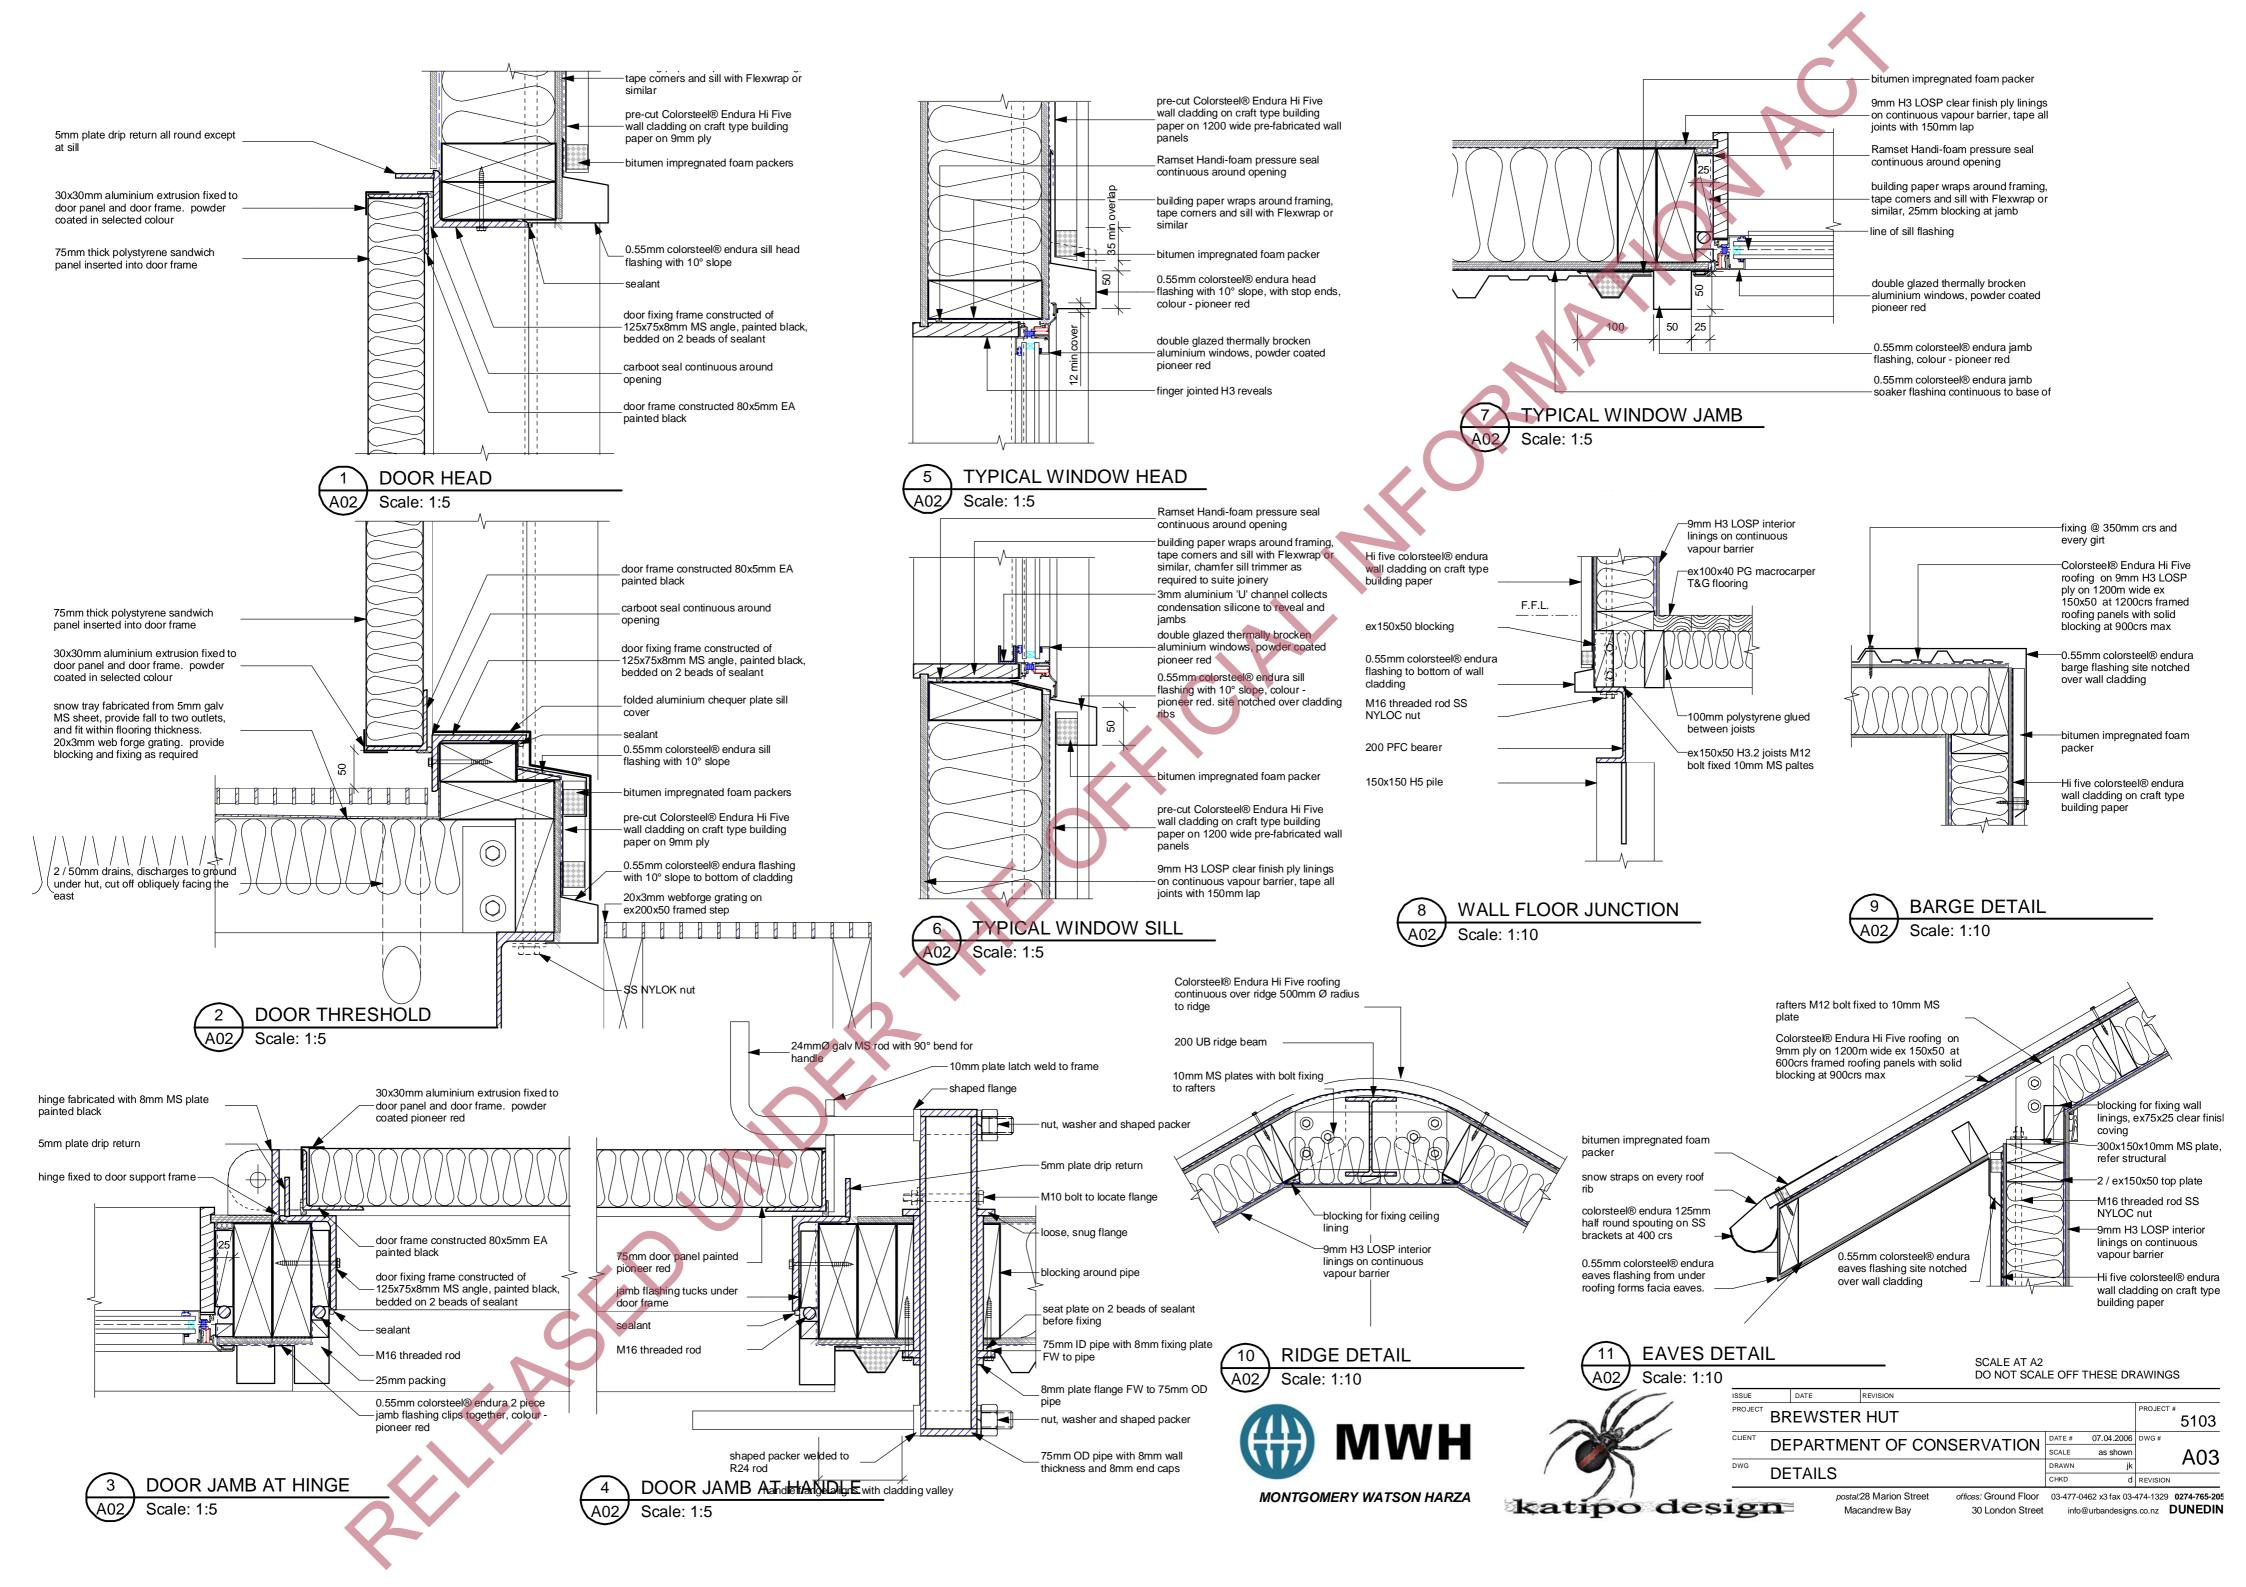


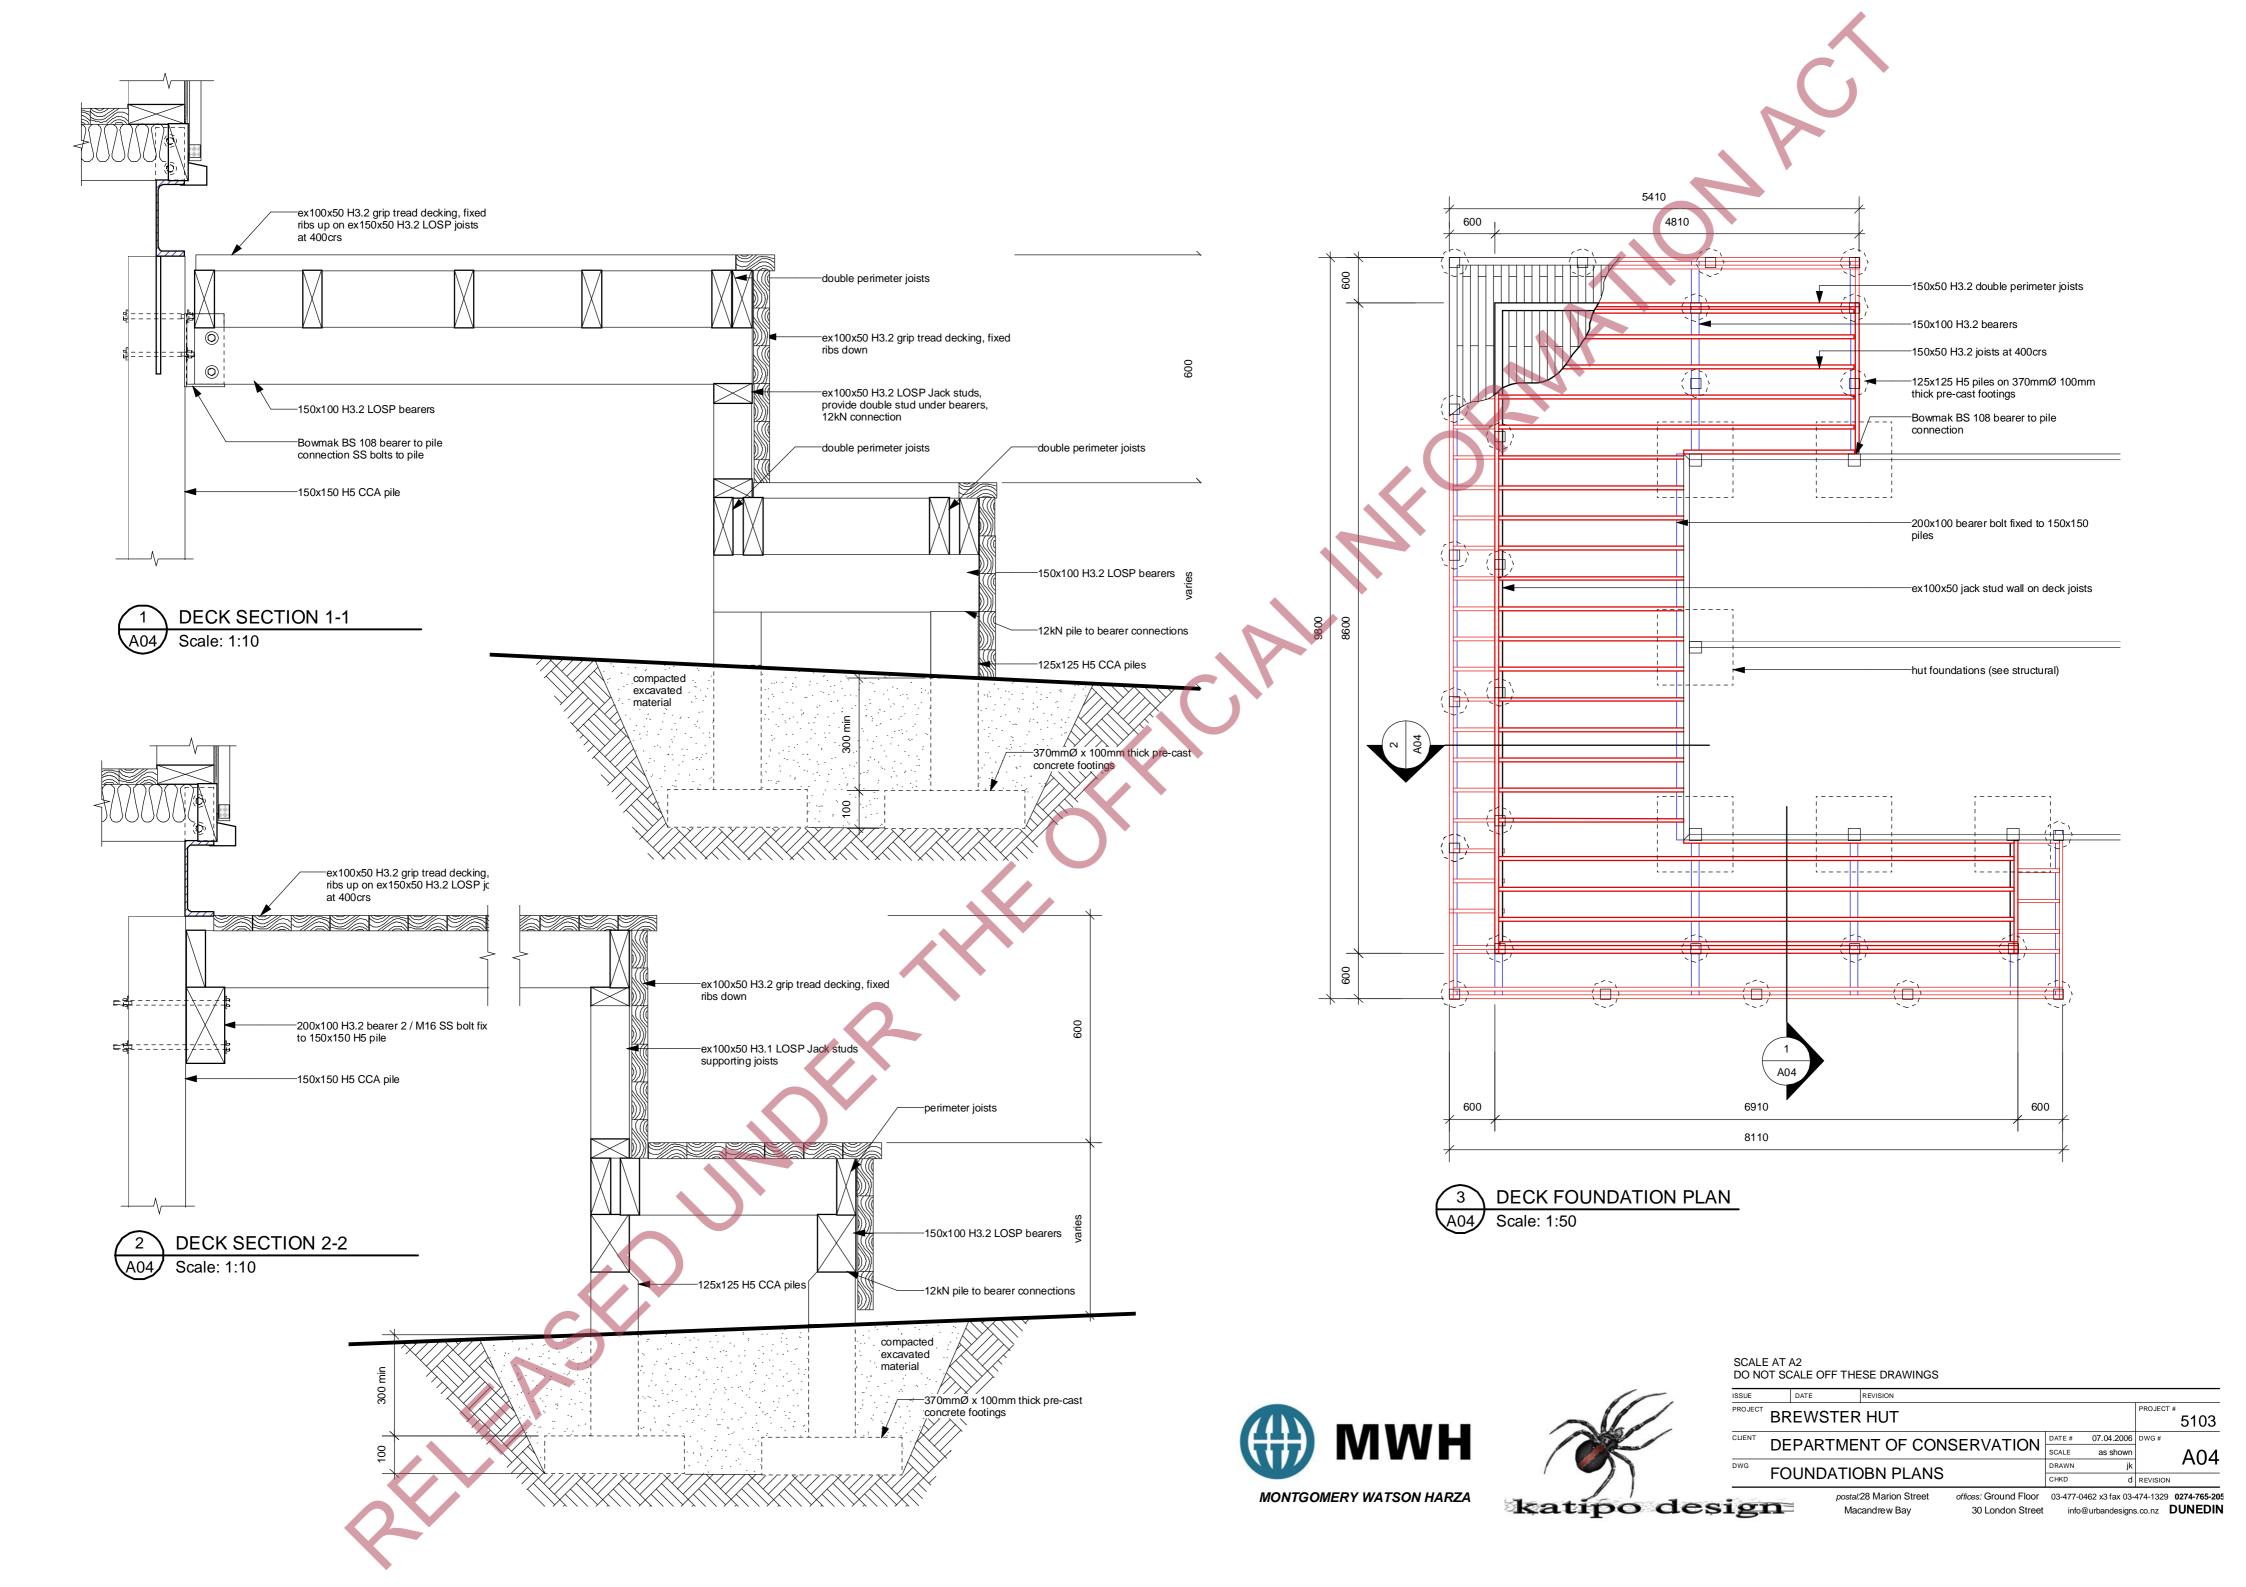


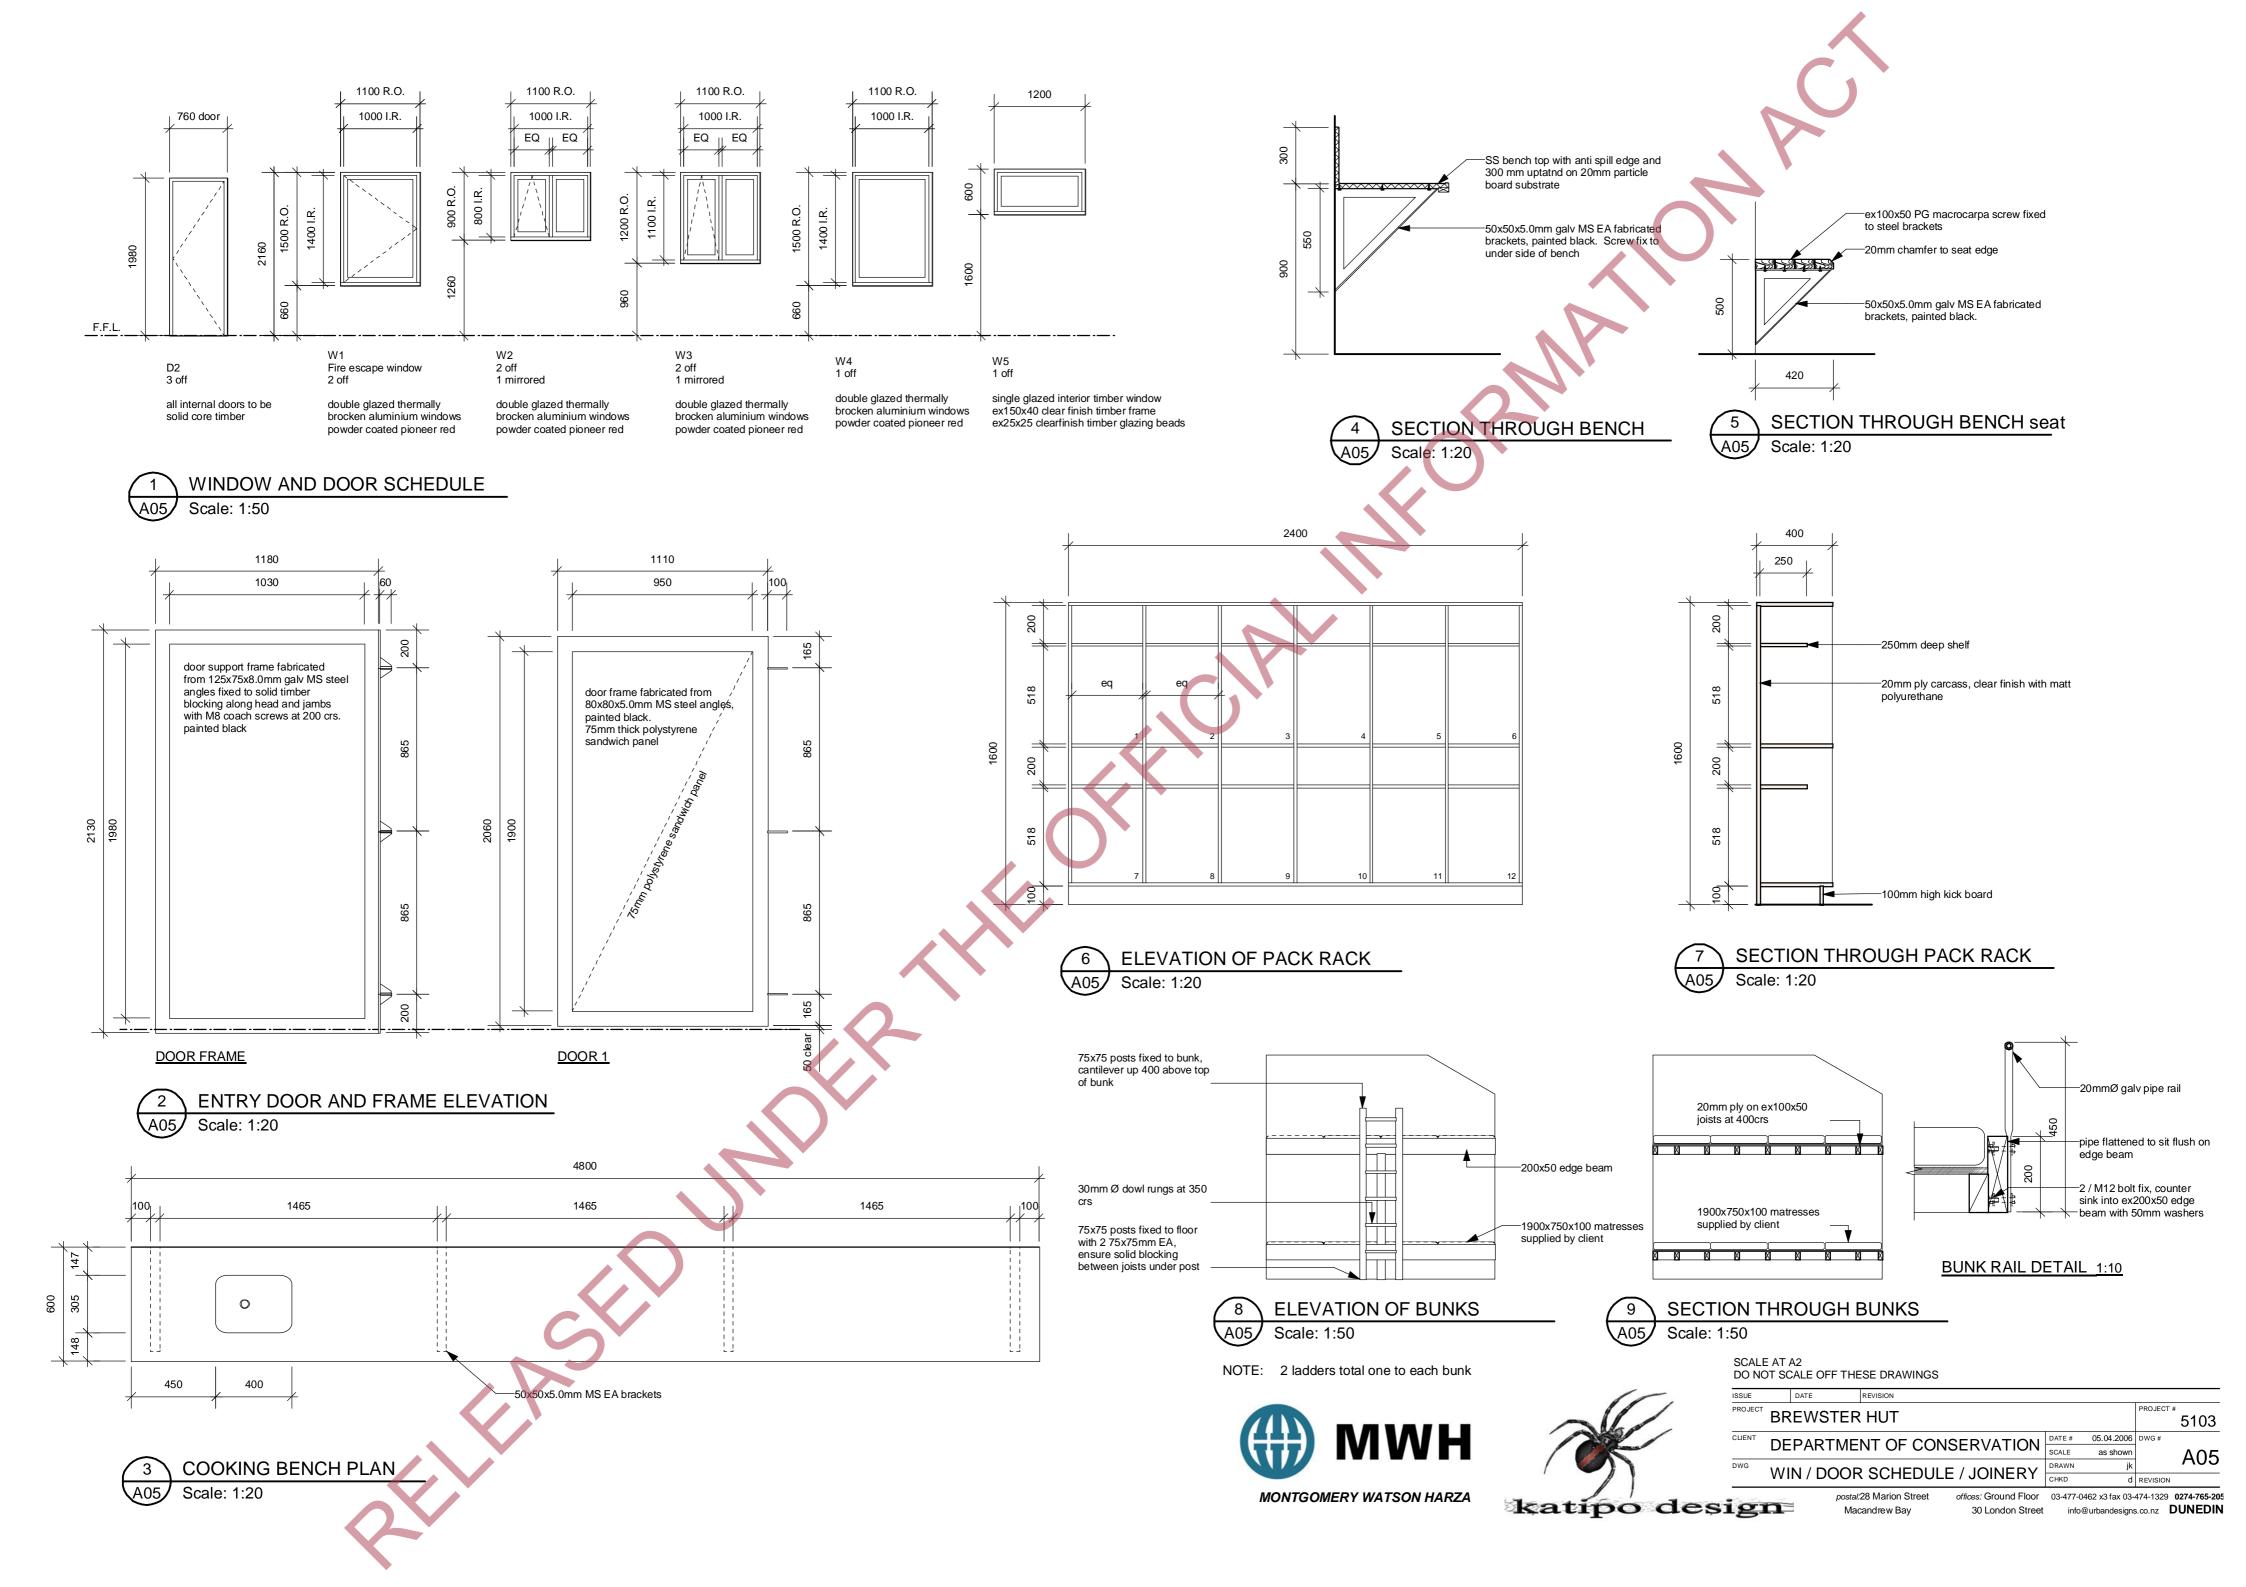


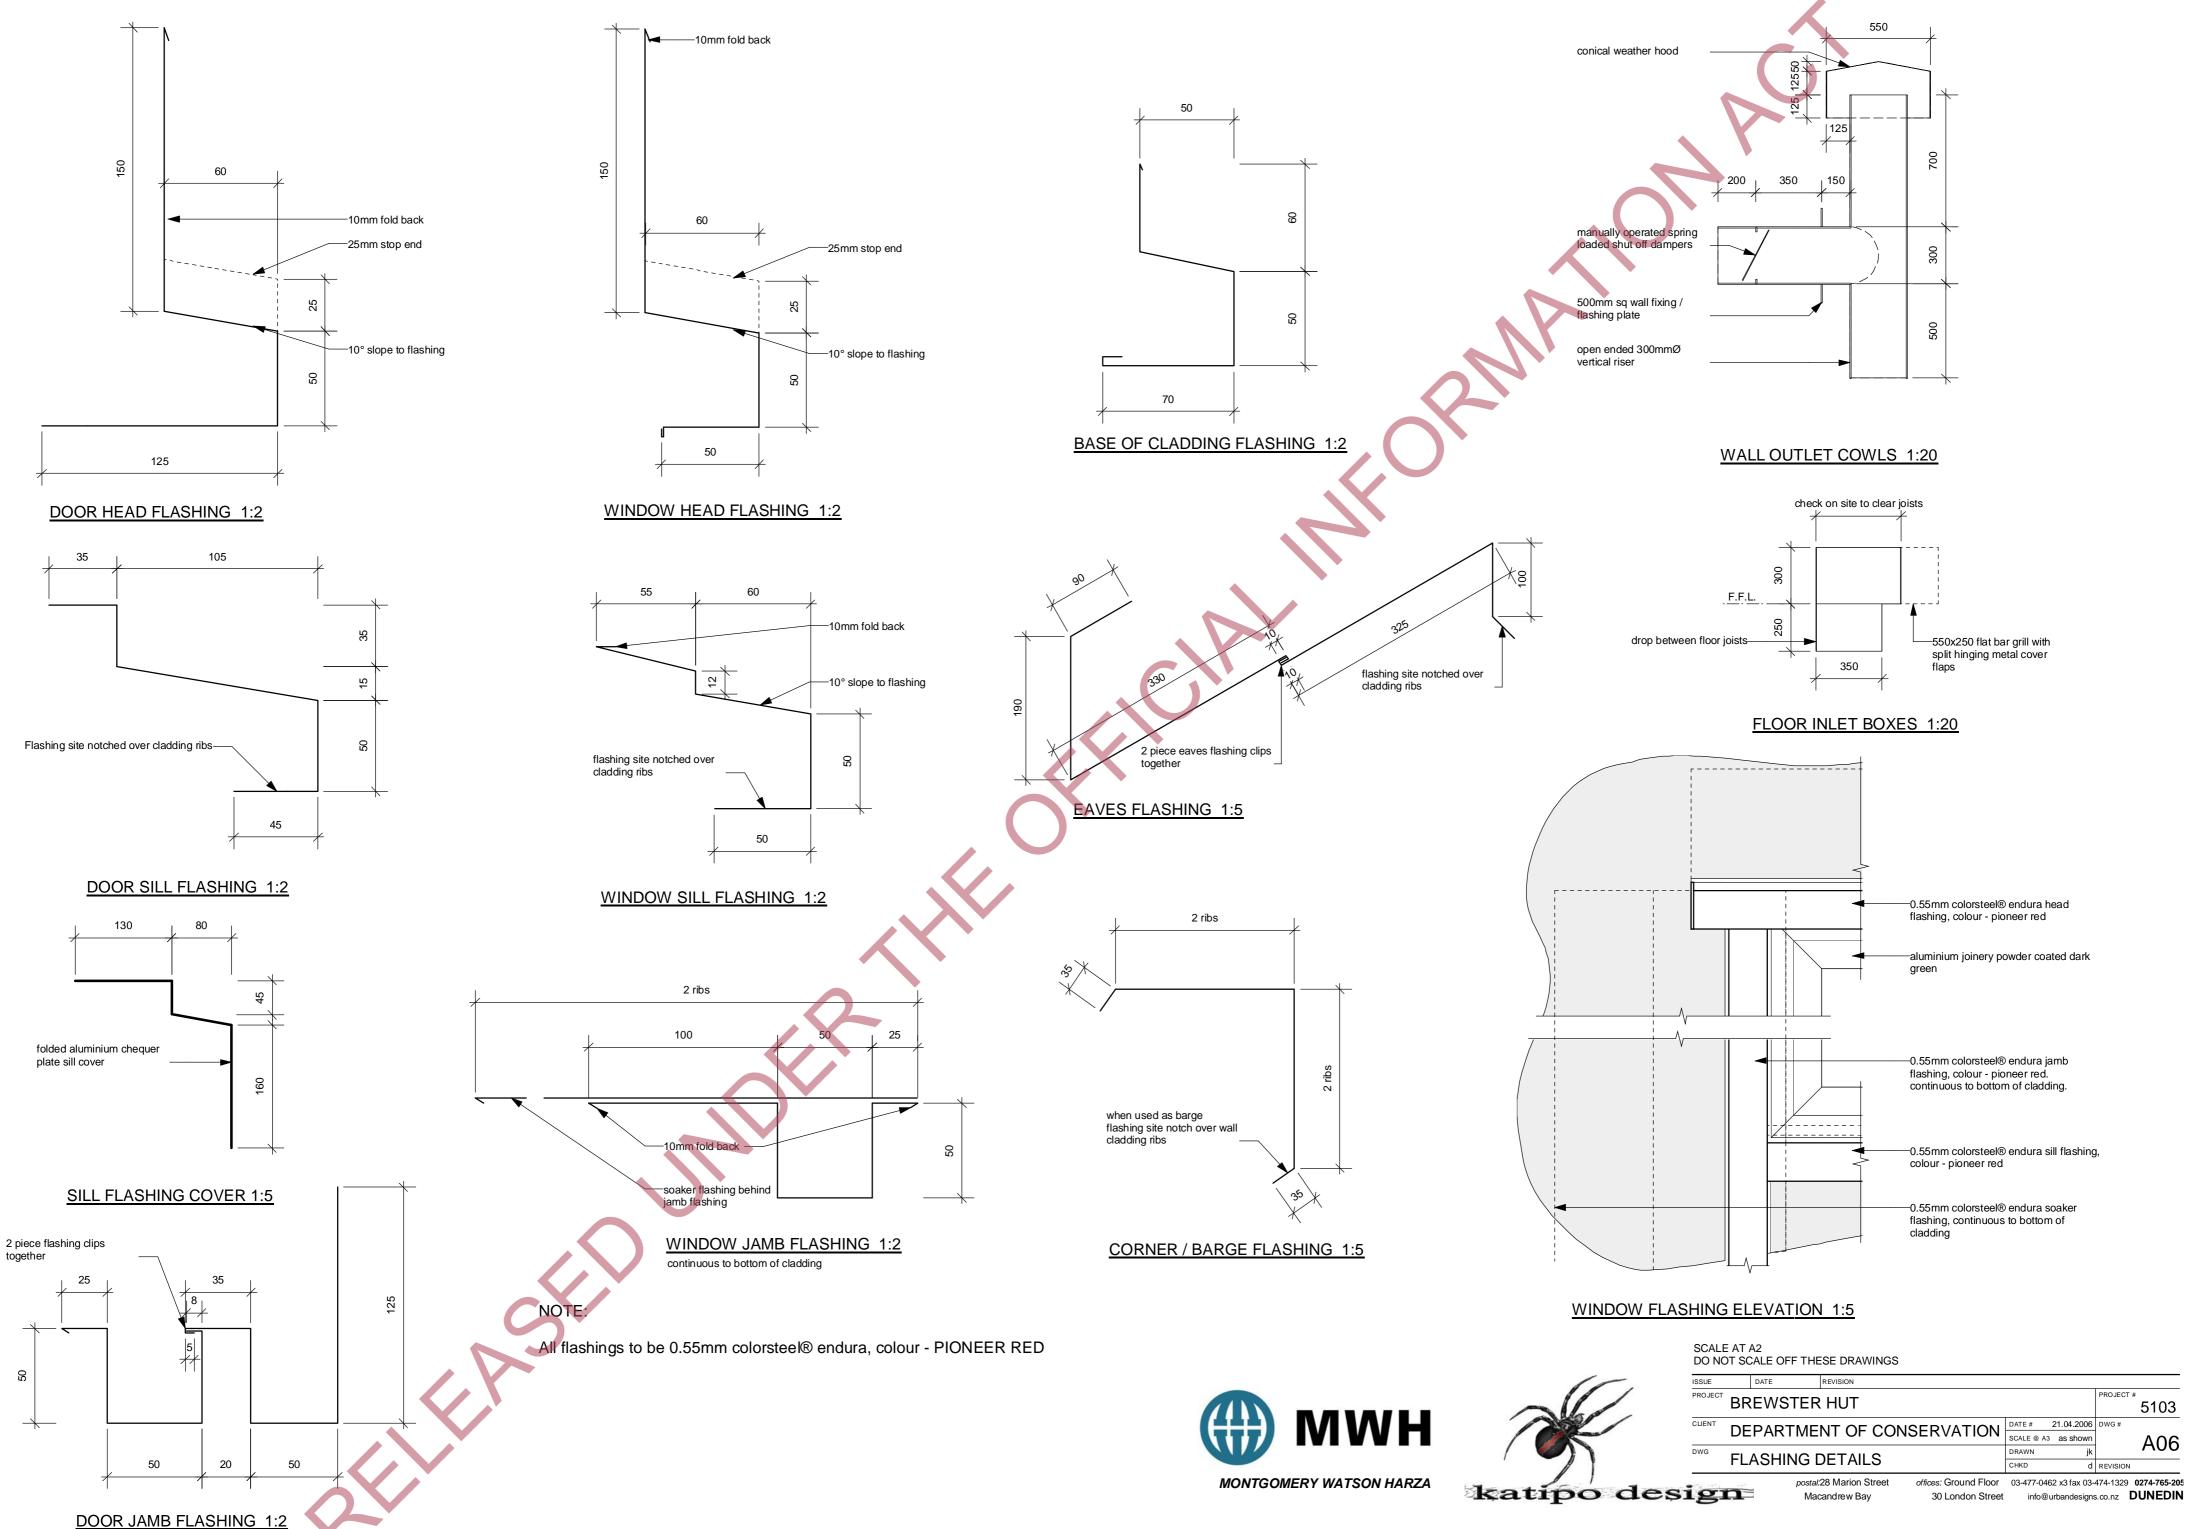


continuous to bottom of cladding

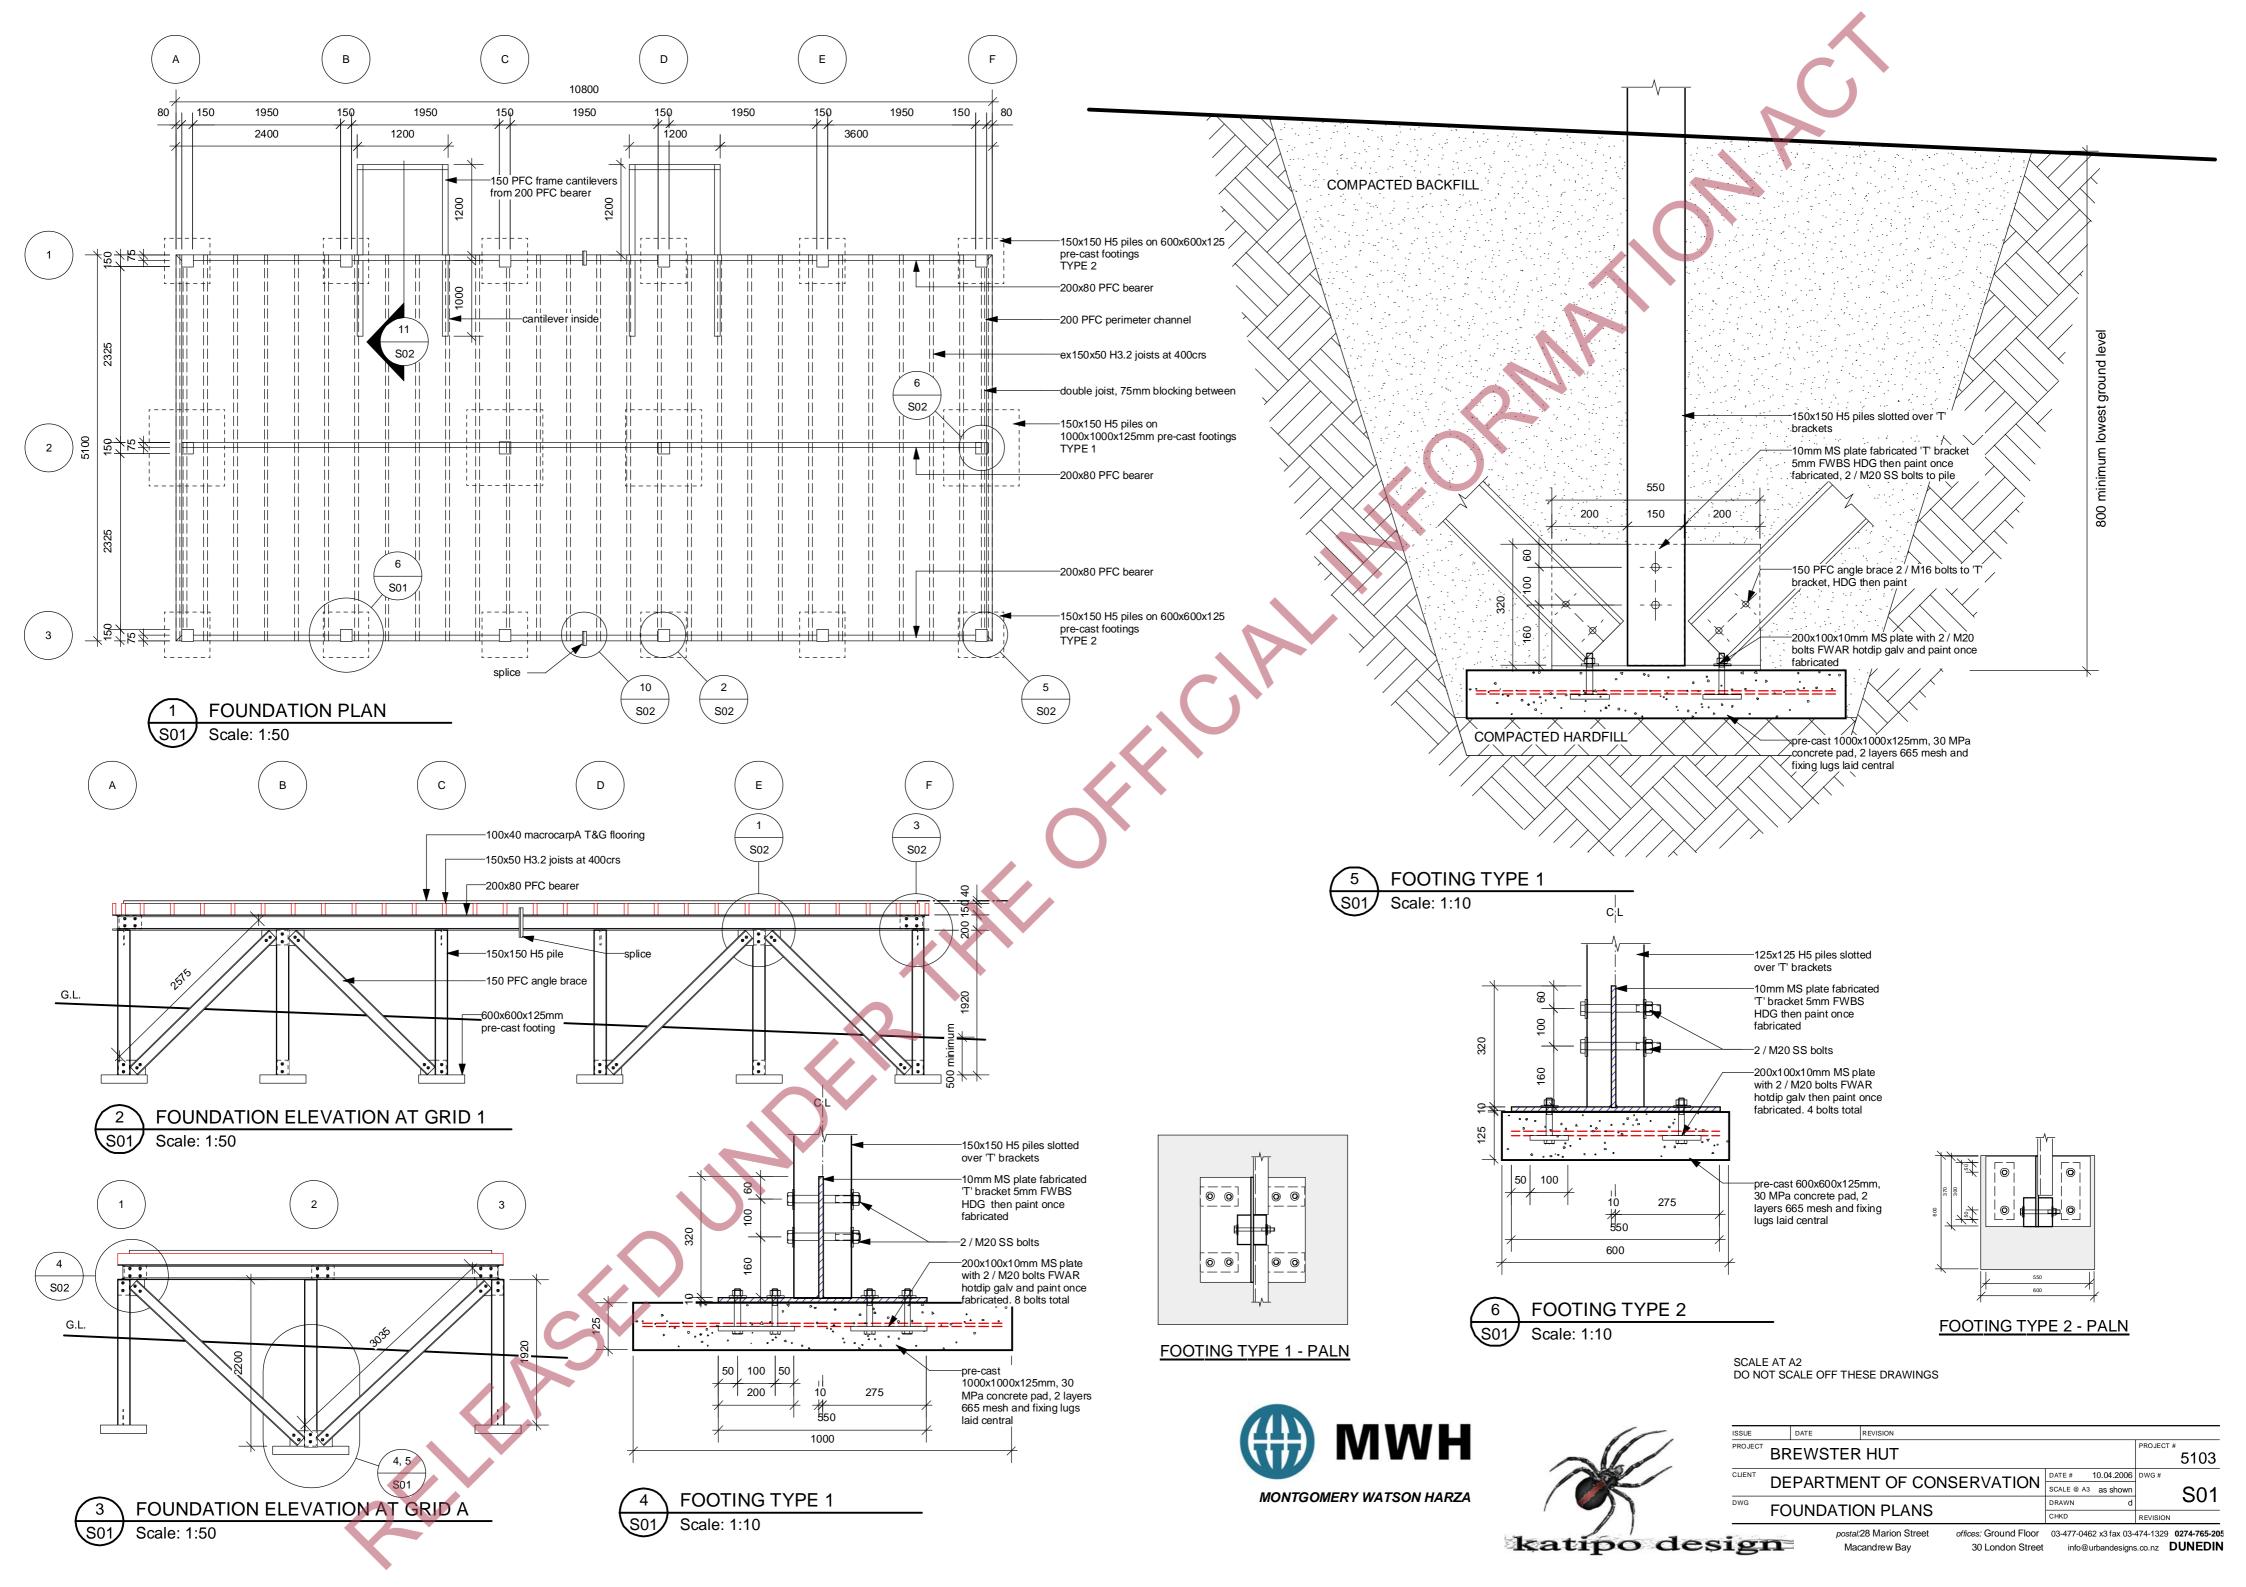

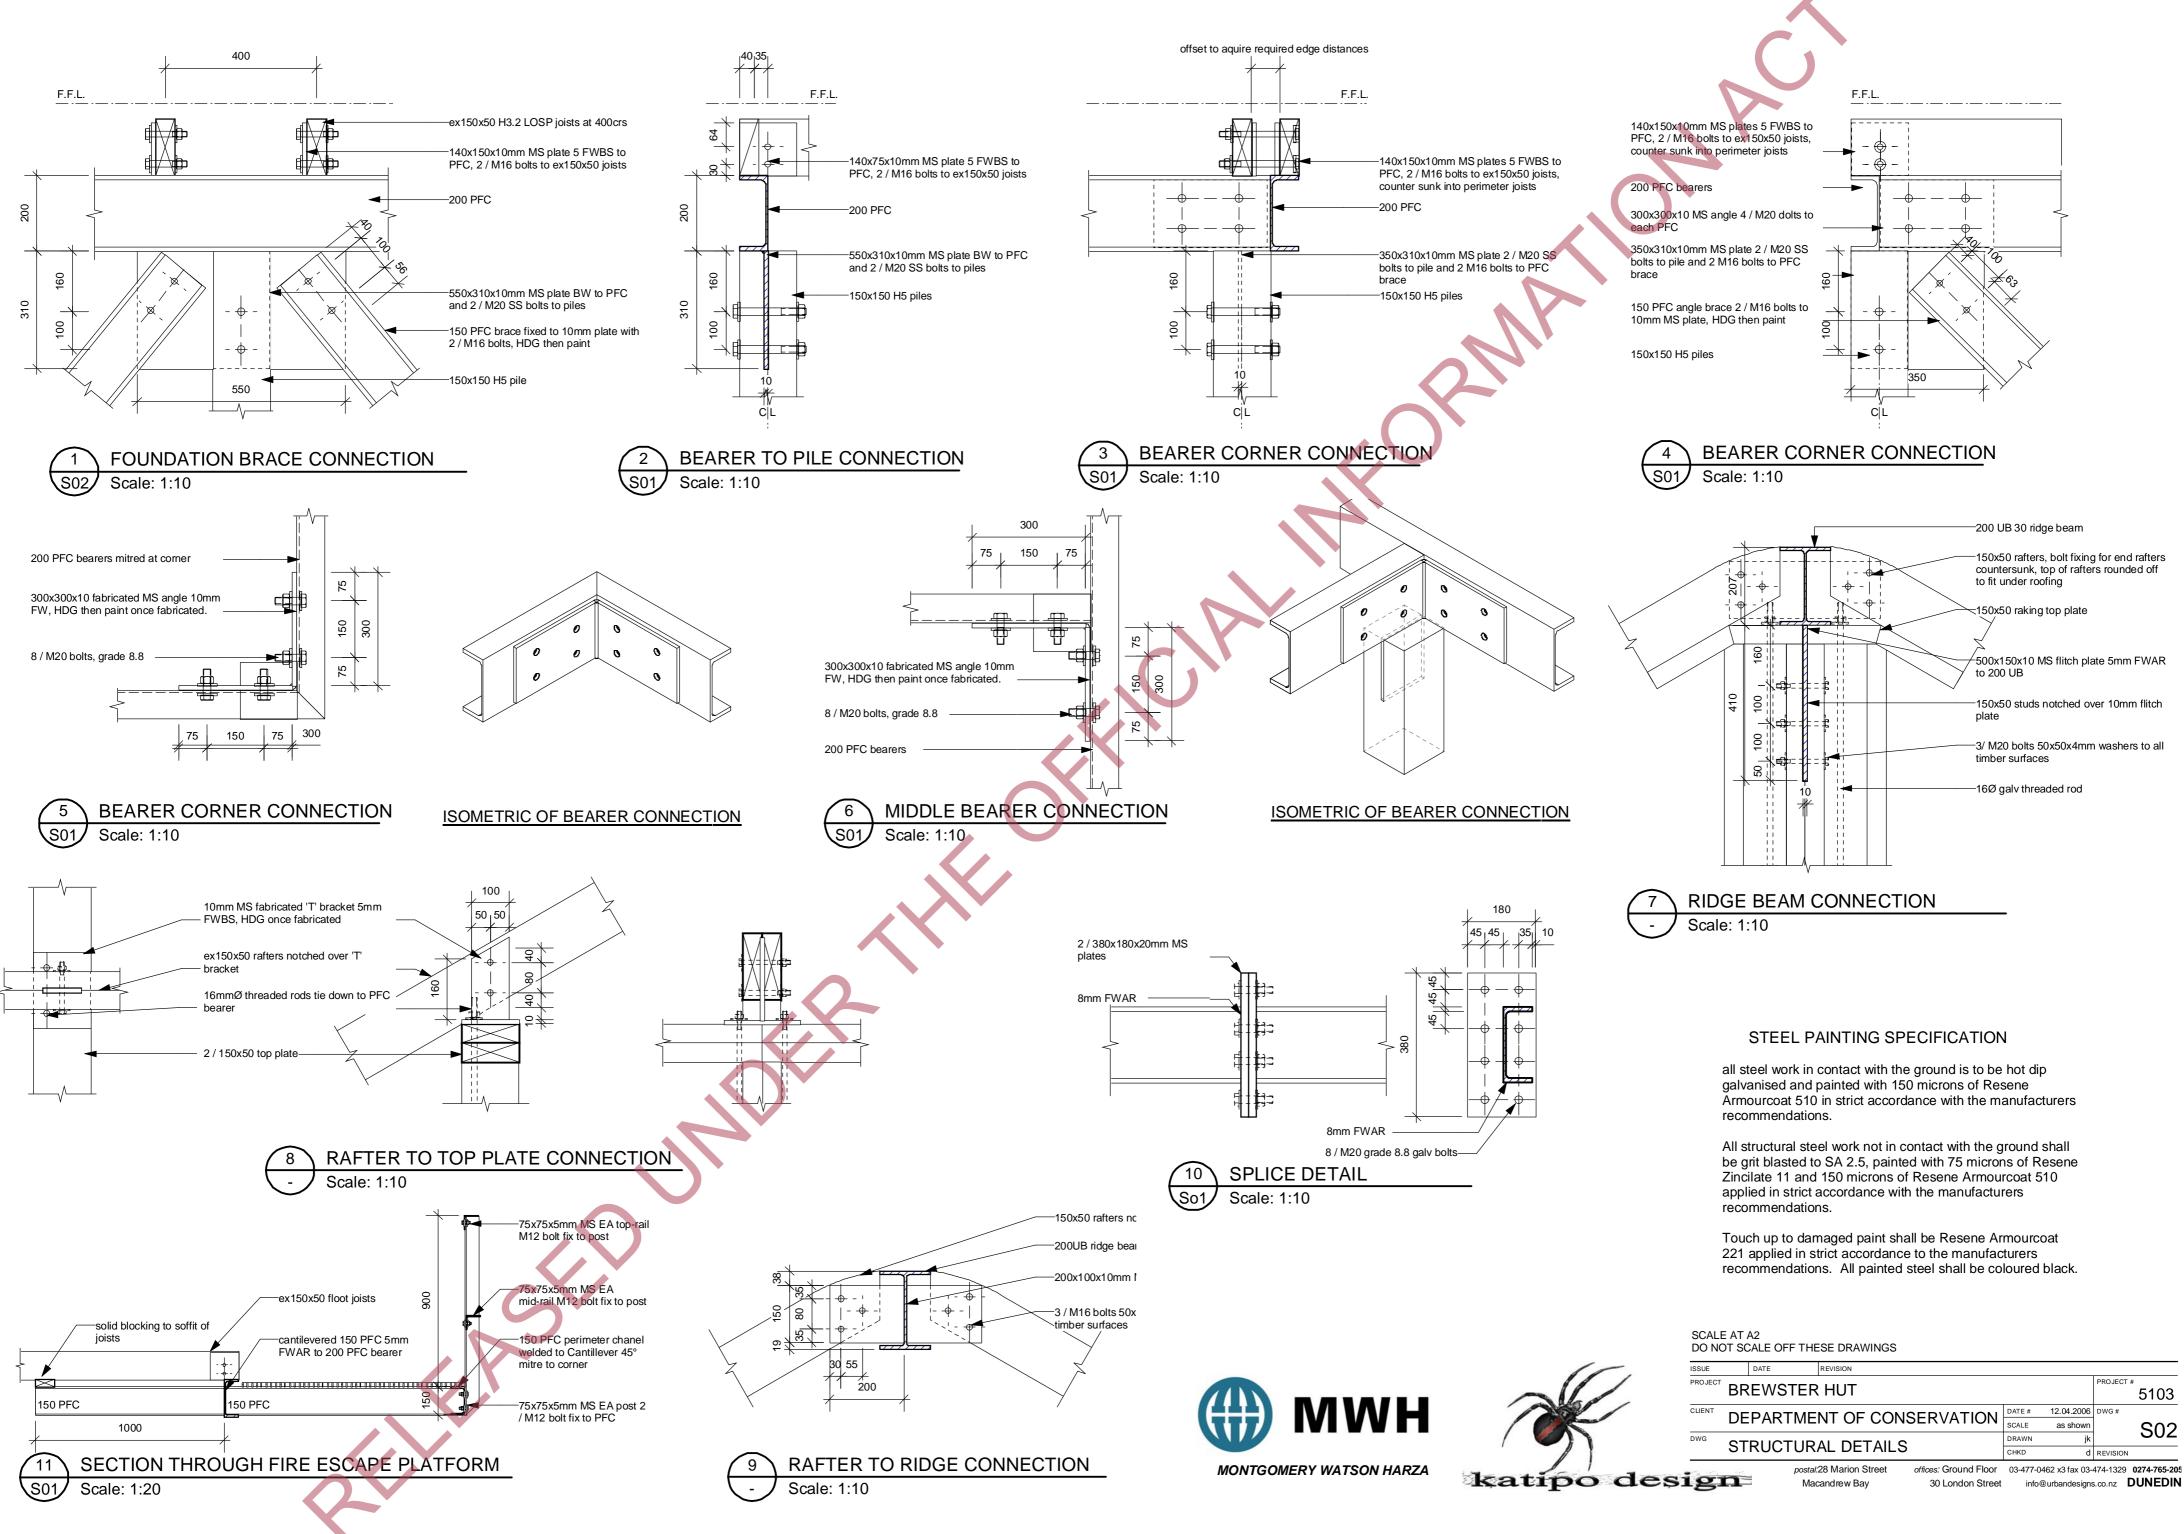


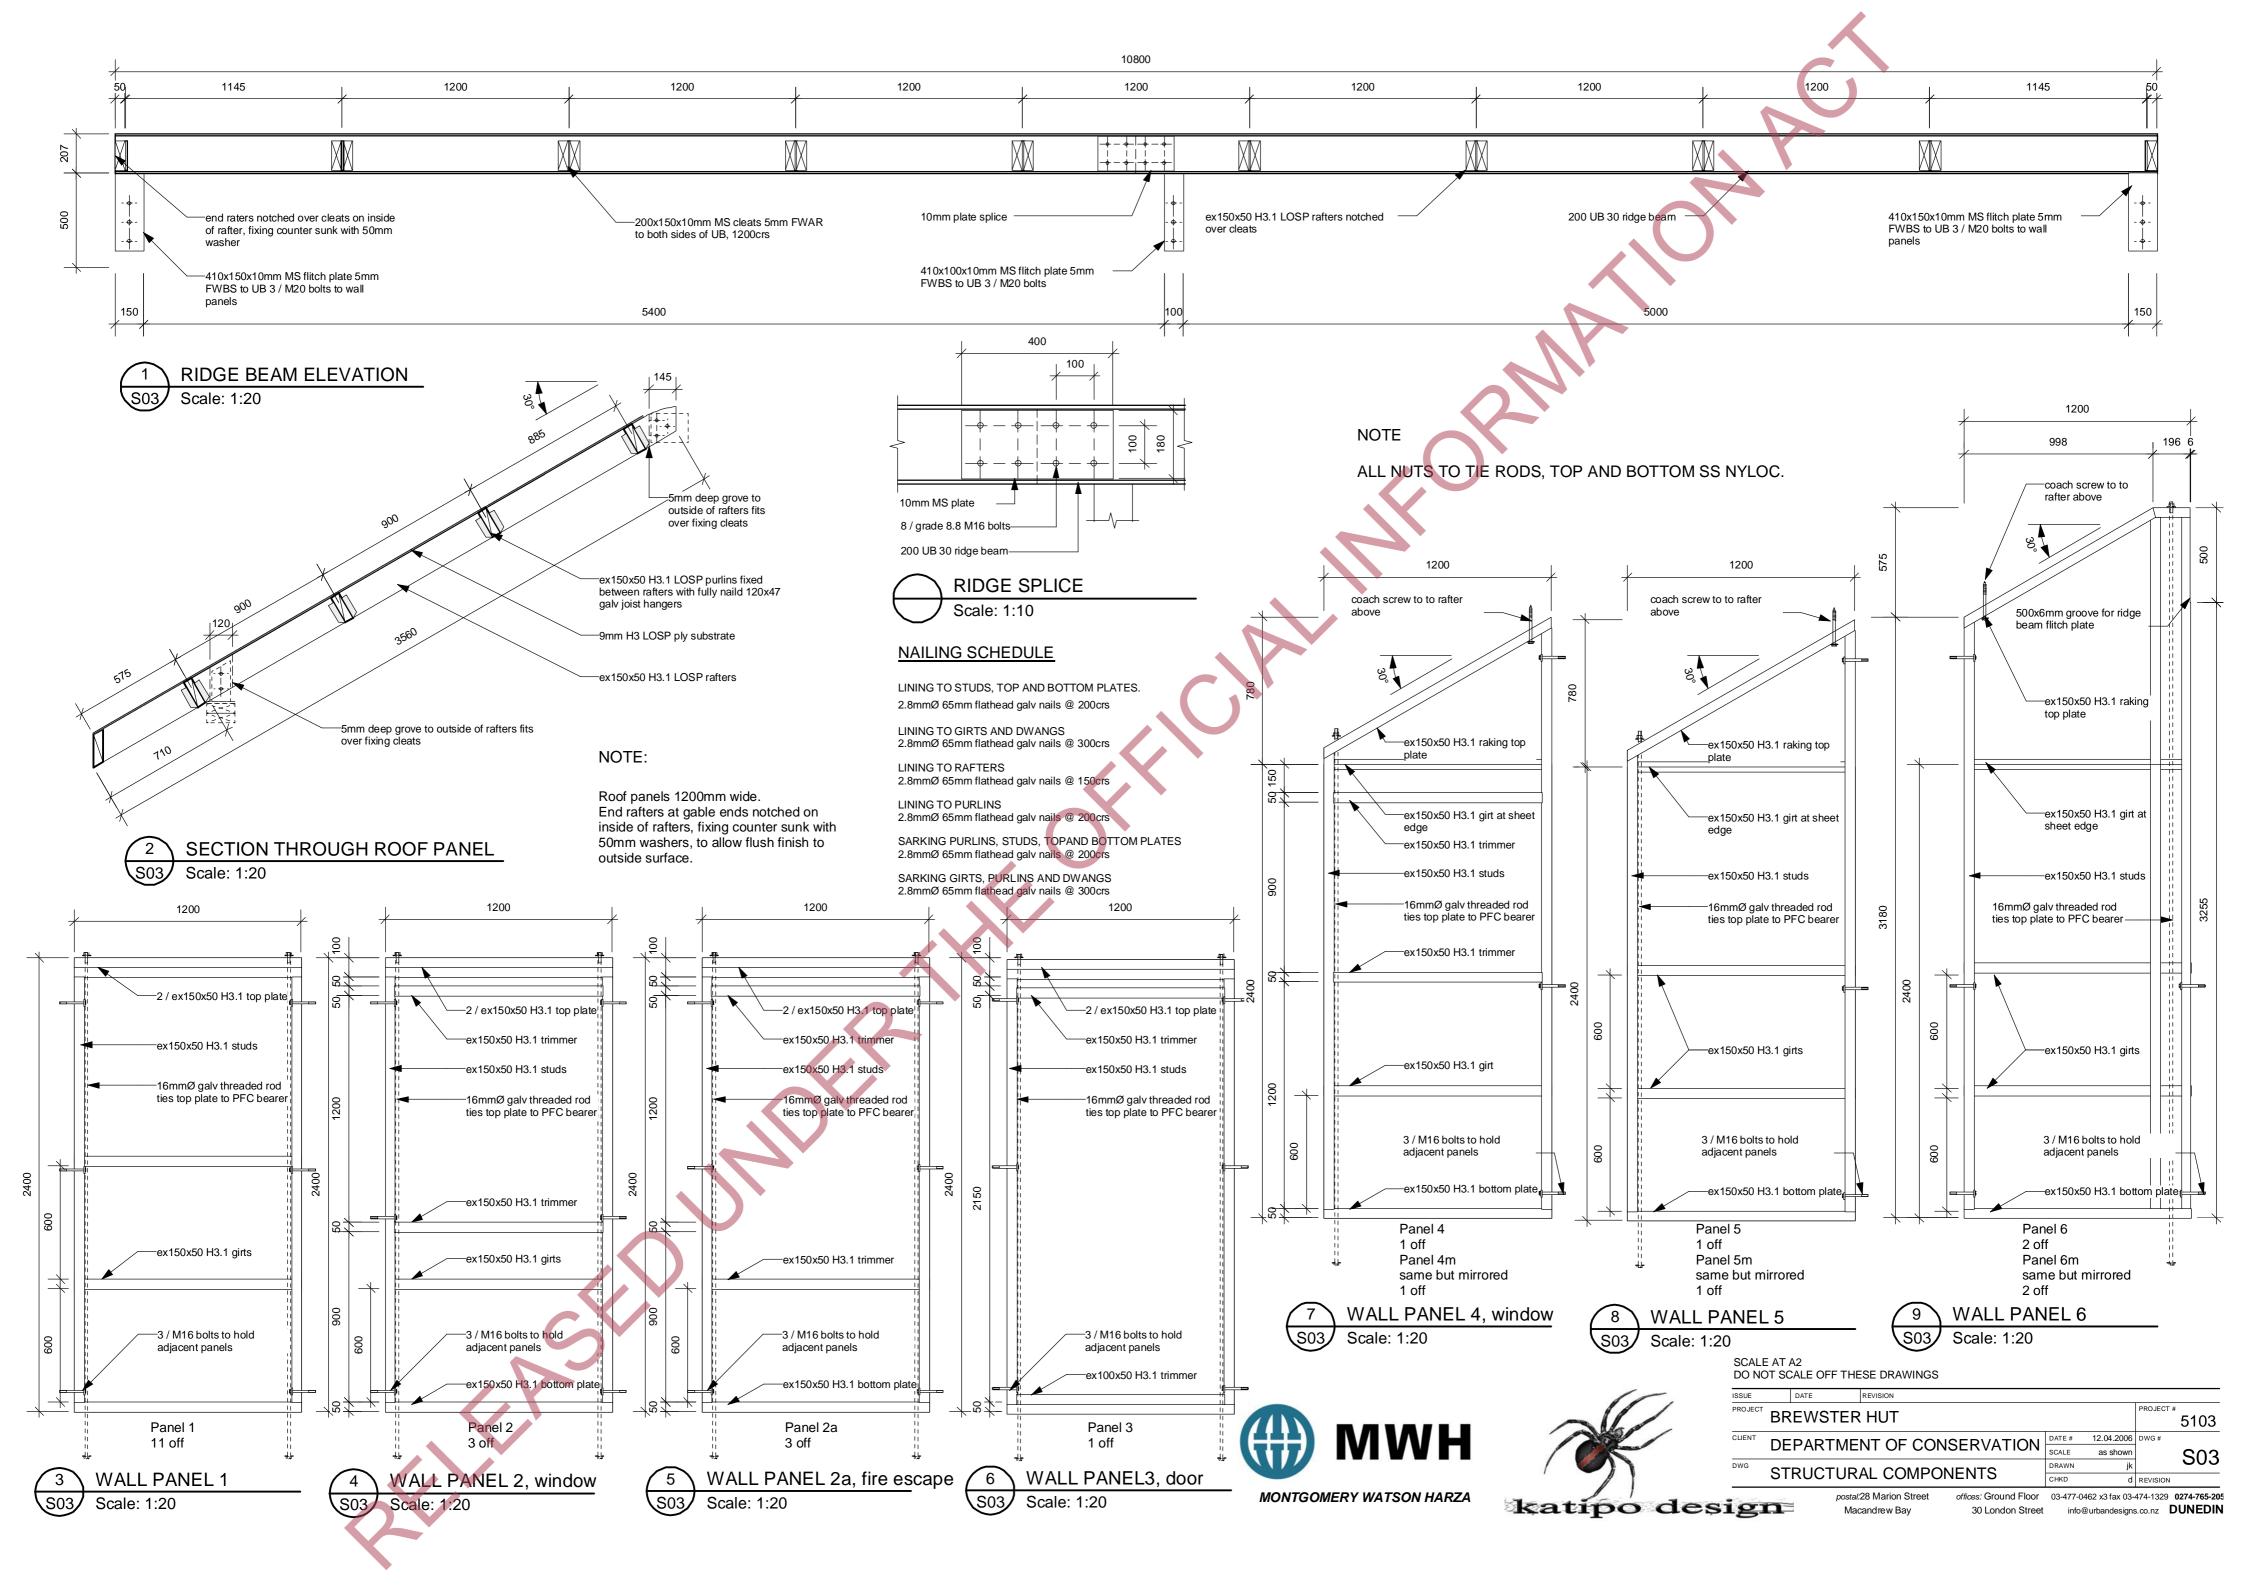


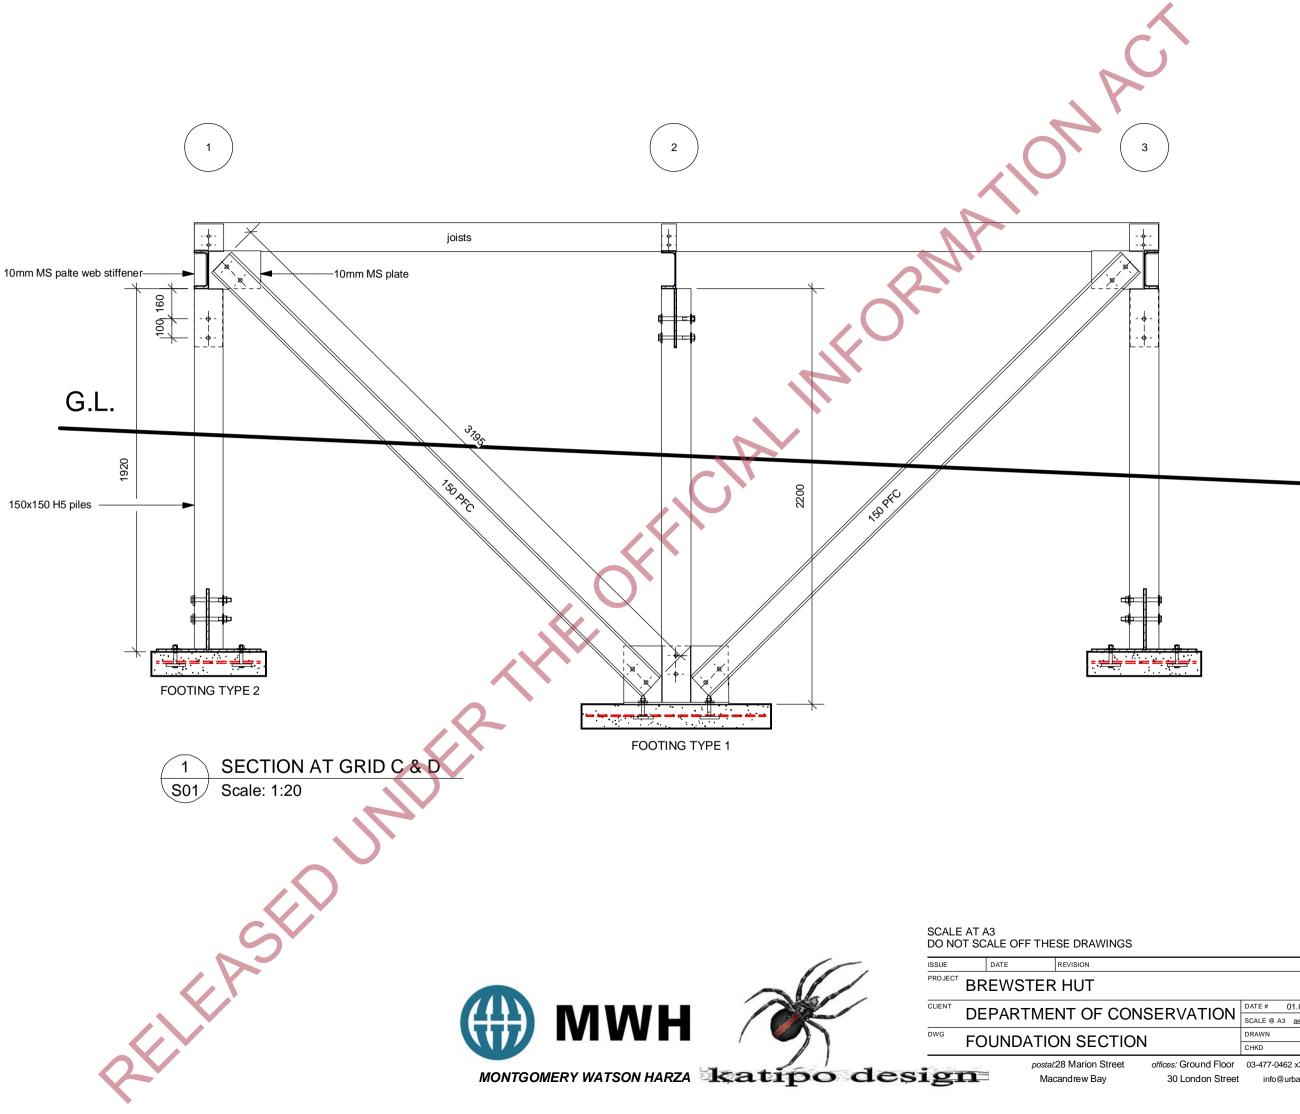


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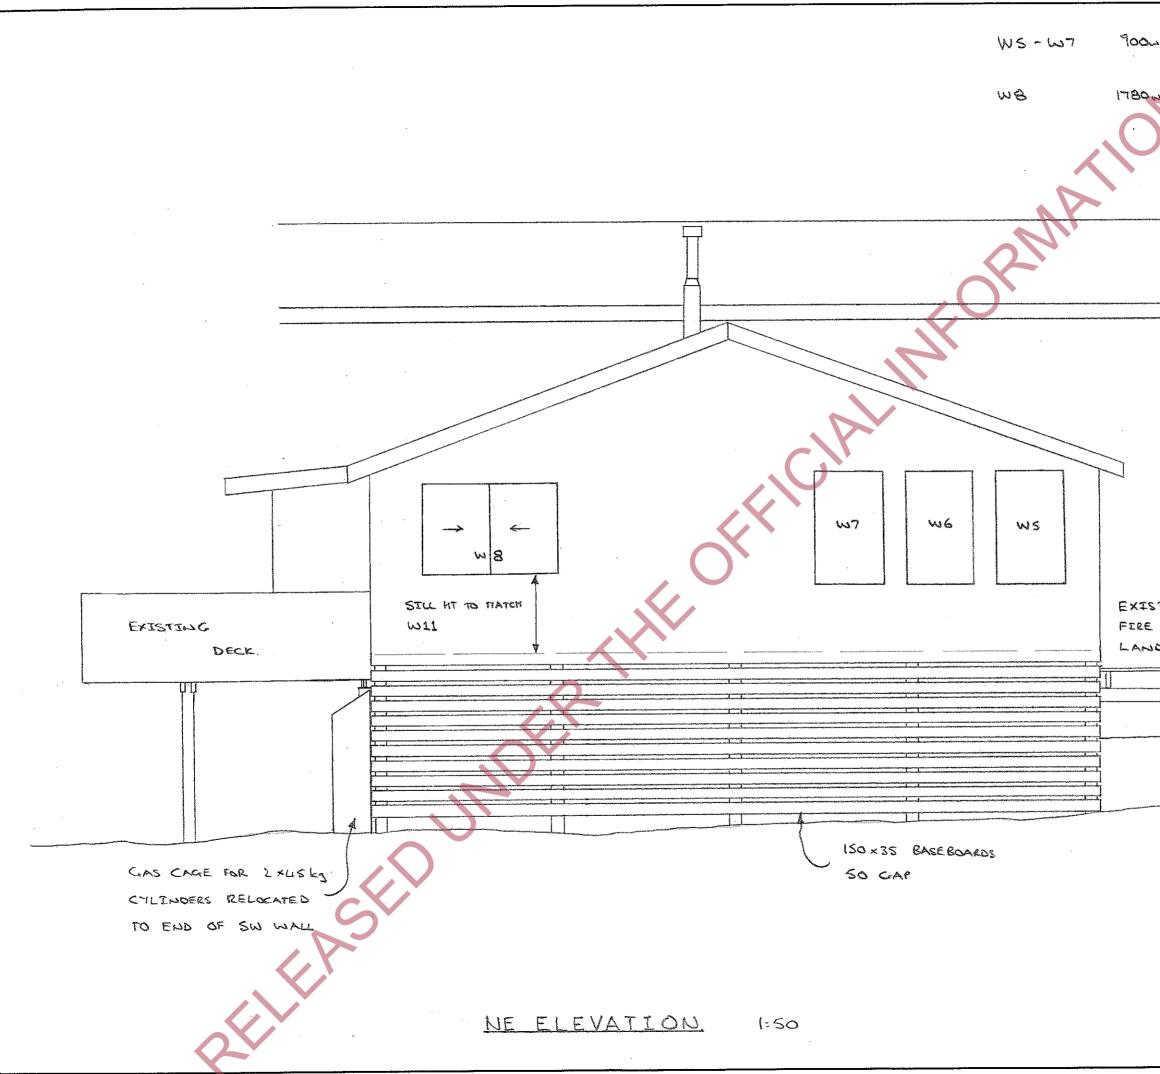
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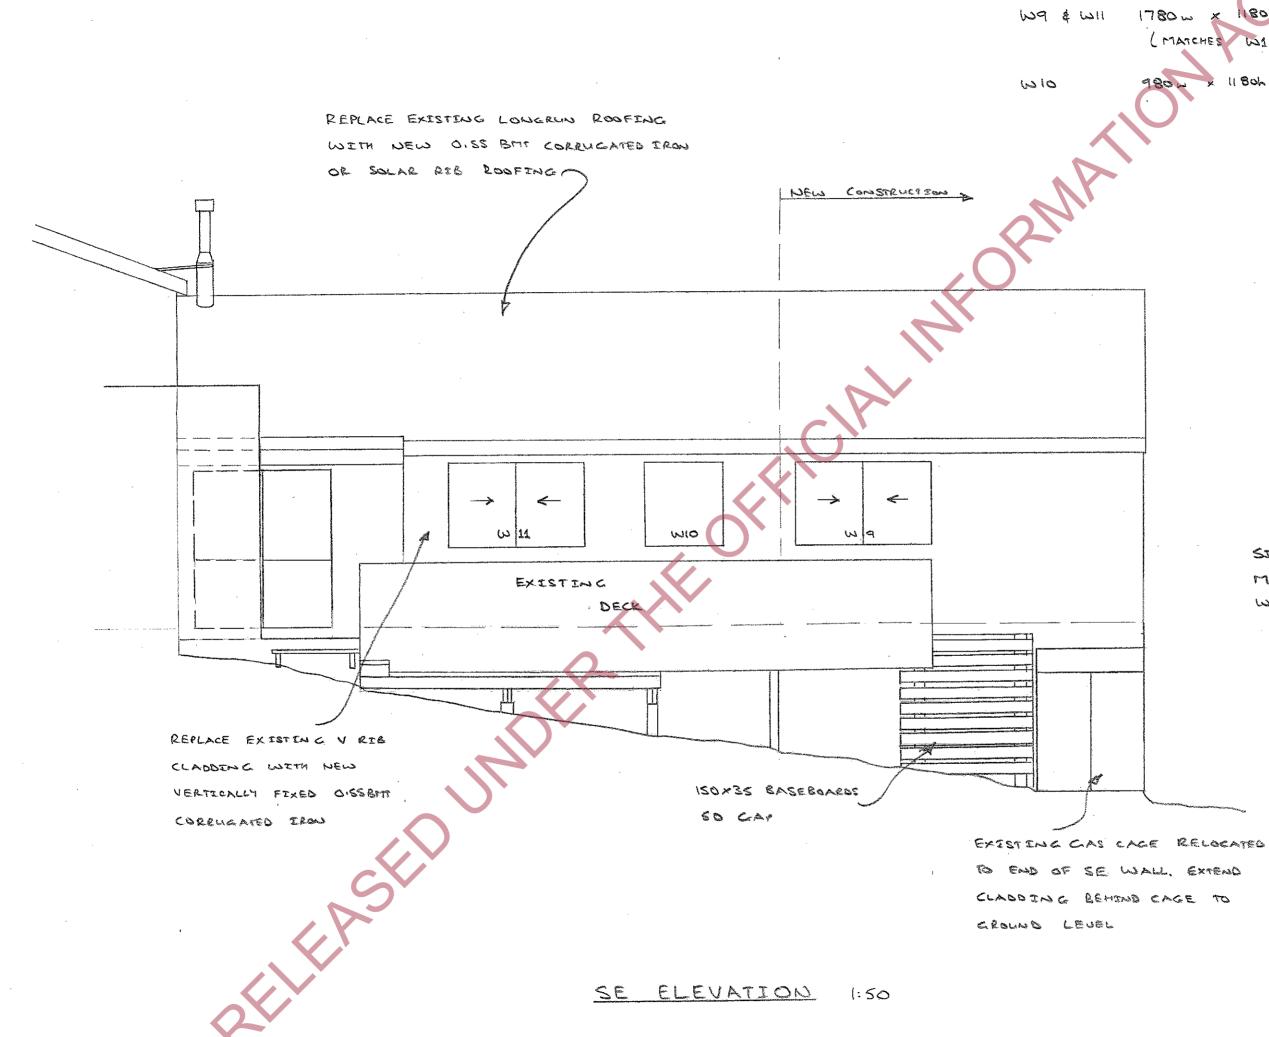


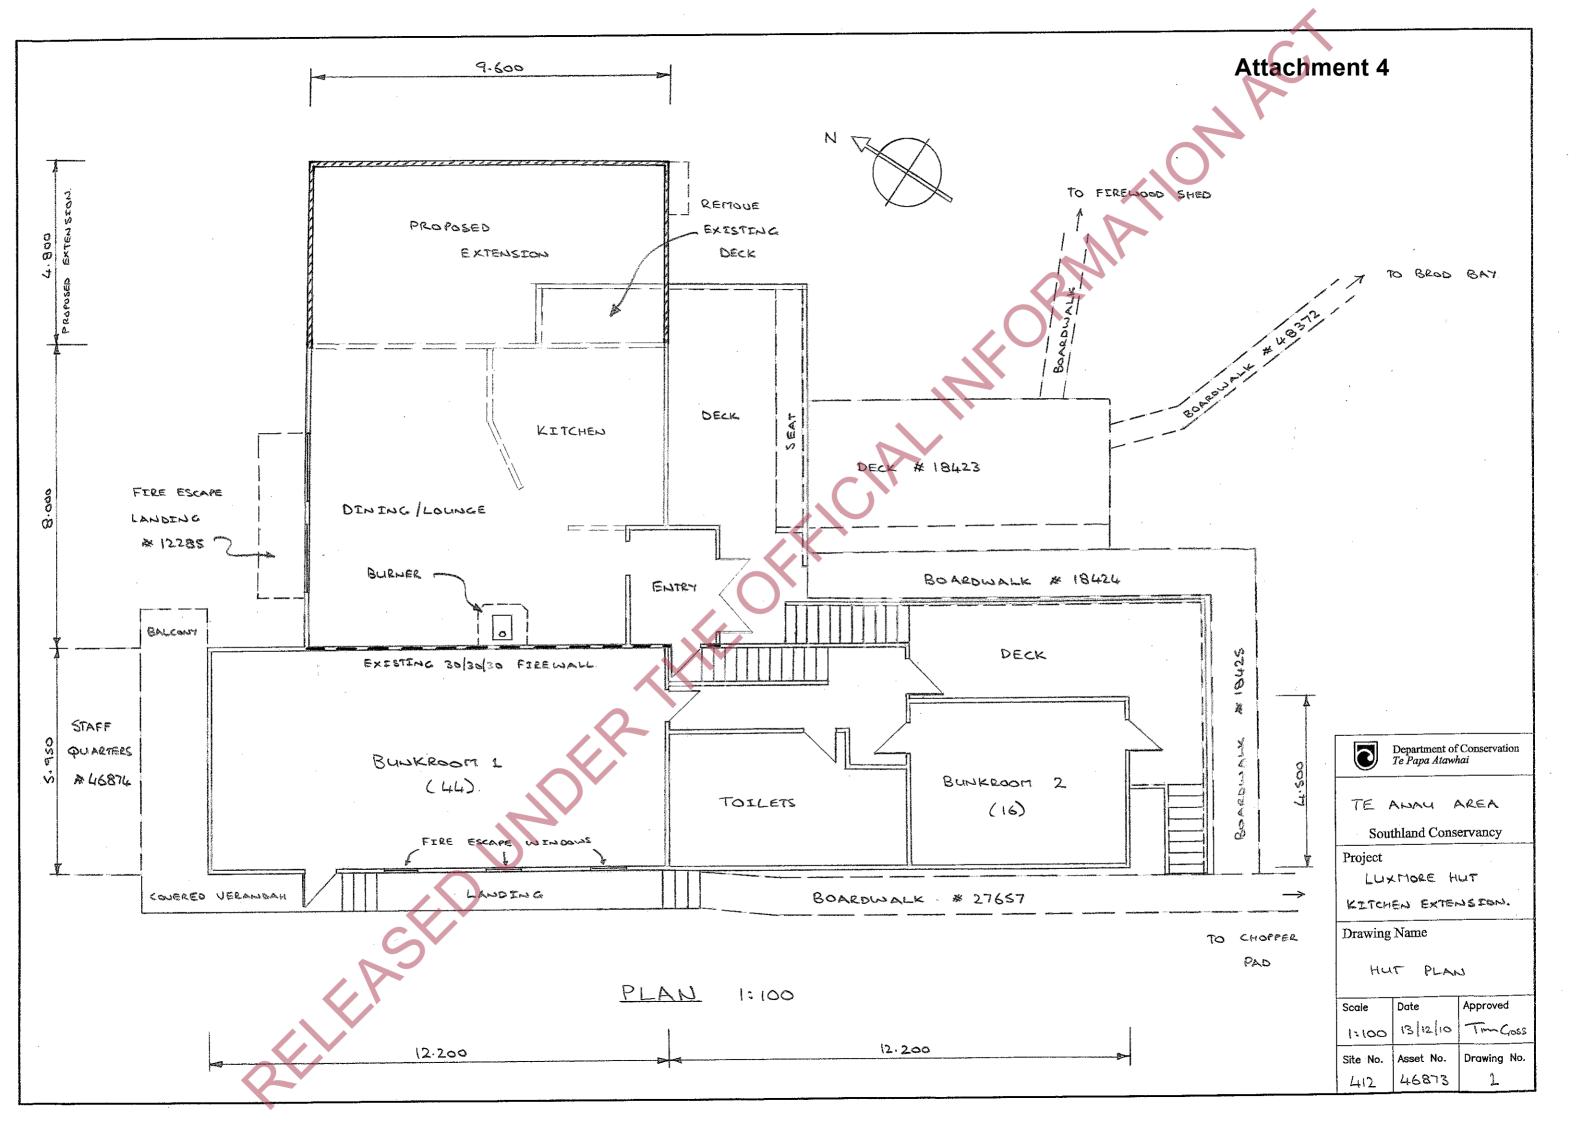

1780- × 1180+ SLIDING (MATCHES VOB, W9 & WII) SIDE HUNG 11804 REPLACE EXISTENCE V-RIB CLADDENC WITH NEW VERTICALLY FIXED OISS BAT) CORRUGATED IRON Department of Conservation Te Papa Atawhai 0 TE ANAU AREA Southland Conservancy Project LUXMORE HUT KITCHEN EXTENSION Drawing Name NW ELEVATION Approved Date Scale 13 12 10 Tim Cross 1:50 Drawing No. Site No. Asset No. 46873 З 412

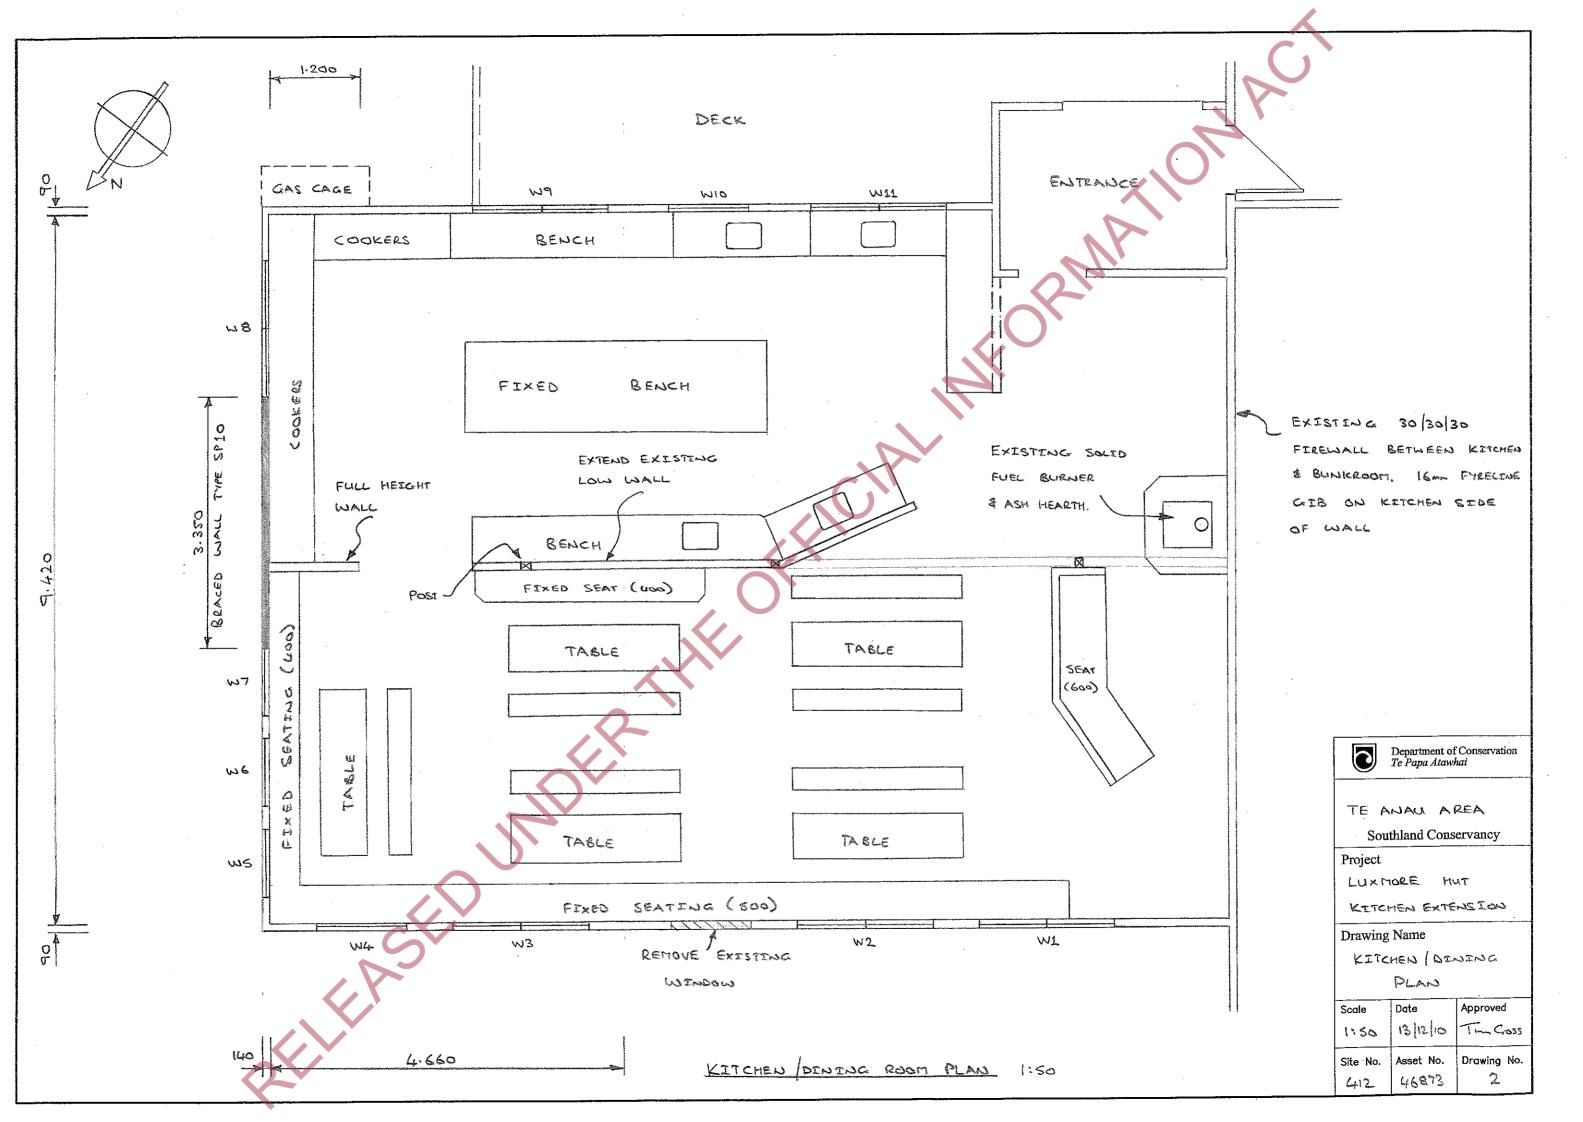


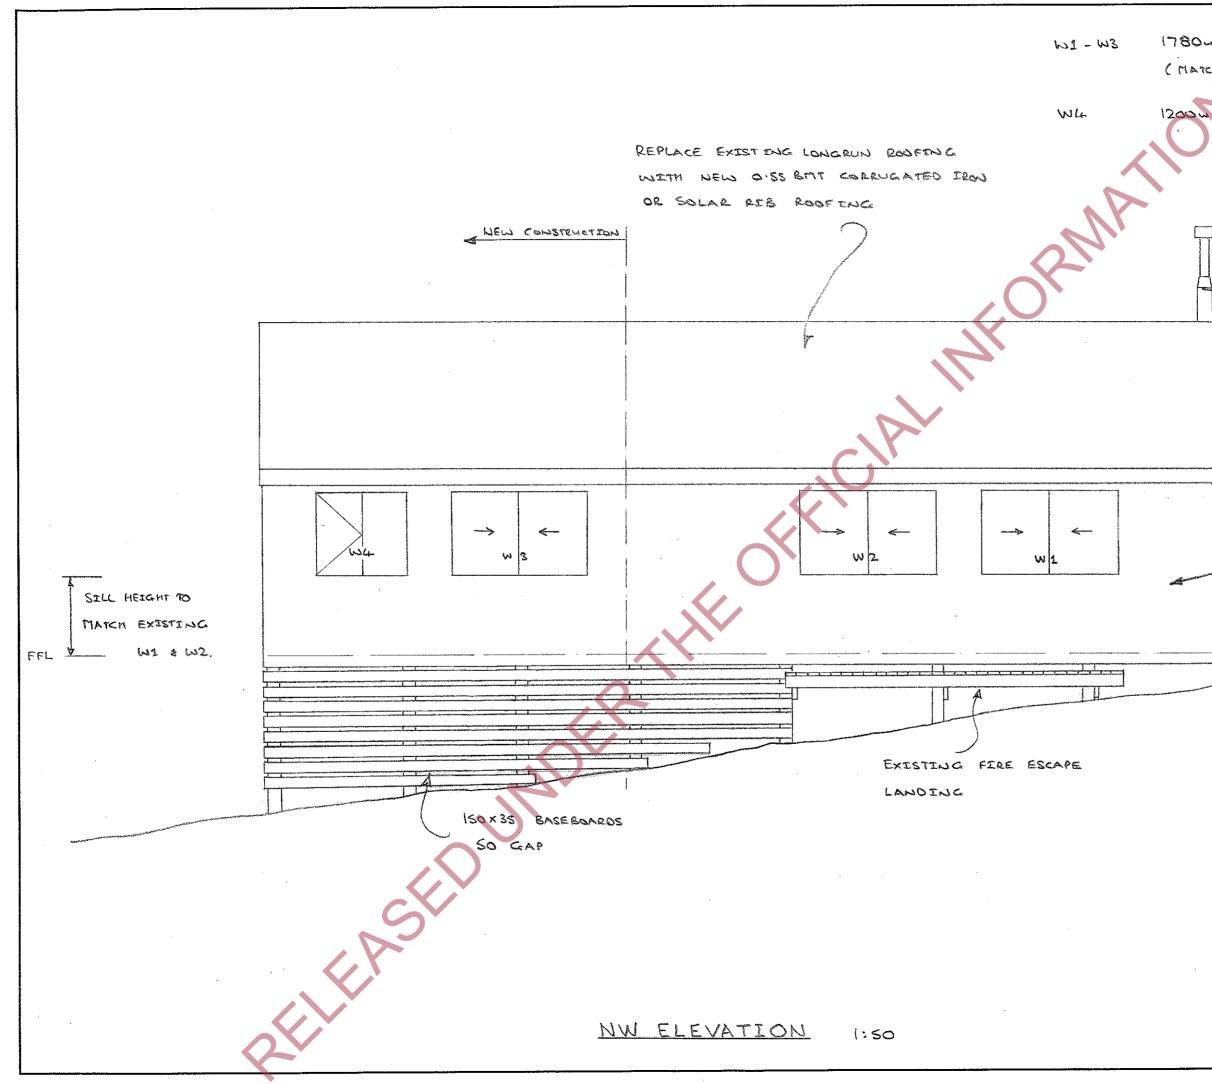NON OPENENG. 9000 x 1500h 1780m × 1180h SLIDING (MATCHES W1, W2, W3, W9 1 (22). EXISTING FIRE ESCAPE LANDING T FFL Department of Conservation Te Papa Atawhai 0 TE ANAU AREA Southland Conservancy Project LUXMORE HUT KITCHEN EXTENSION Drawing Name NE ELEVATION Scale Date Approved 13/12/10 Time Gross 1:50 Drawing No. Site No. Asset No. 46873 412 4





IIBOL SLIDING × (MATCHES W1 - 3 \$ W8) 1180h NON OPENENG. SILL HEIGHT TO MATCH EXESTENC WID & WII. I FFL Department of Conservation Te Papa Atawhai 0 TE ANAU AREA Southland Conservancy Project LUXMORE HUT KITCHEN EXTENSION Drawing Name SE ELEVATION Approved Date Scale 13 12 10 Tim Goss 1:50 Asset No. Drawing No. Site No. 46873 5 412

STEAP EXISTING RAFTERS WITH 190 XUS MIGG 8 EXISTENCE 250 × 100 NEW OSS - CORRUGATED IRON OR SOLAR RIG ROOFING OPPOSITE STOR D CERLING JOISTS RIDGE BEAM OVER COVERTER 407 ROOFING UNDERLAY OVER 2 ROWS NAILS & 200 cs. EXISTING ROOF STRUCTURE - 90×45 PURLOWS & 9000 MULTIGREP (12 WAILS) ON 12.5mm PLY ON 180×65 RAFTERS @ 1200 (5 EACH SIDE OF RAFTER NEW 2/190 x45 MSG 8 JOJET HANGER 126×47 CELLING BEAMS CUT 4/14, × 100 TYPE 17 (ZU WAELS) BETWEEN EXISTING POSTS GALVANESED SEEEUS 140 x 35 EDGE MEMBER 10 CELLING DIAPHEAGH 9.5mm CD ECOPLY CEILING JOIN 200mm ONE SIDE OF CELLING JOIST EAVES DETAIL ON TO X35 BATTENS & 600 ... USENG PRIDA BNIS NAILPLATE ON TOP FACE. SEE SHE 11 ON 140 × 45 MSG & CEILING JOISTS & 1200-5 R3.6 LILTRA BATTS CETCING INSULATION. EXISTING FLOOR 20mm T& G 12.5 CD PLY LEWING ON (PLY SHEETS LAID IN STRETCHER ON 140 × 45 JOISTS & 450 cs EXISTING GOXUS FRAMING BOND PATTERN - FACE GRAIN ON 140×90 BEARERS (NEW FRAMEN & TOXUS MELS REPLACE EXISTING V-RIB 11 TO CERLENA BESTS) Studs @ 400 cs) CLADDING & WALL WEAP WITH NEW CONSTRUCTION 20mm CD ECOPLY O. LO BATT CORRUGATED TRON ON LYOXUS MSG 8 JOISTS & 600 CS OVER THERMALLAFT 213 BUILDING ON 2 190 x 45 MSGB BEARERS PAPER ON THERMAKRAFT (PLY SHEETS LAID IN STRETCHER BONN COVER UP BUELDING WRAP NEW SSMM ERPOL EXPANDED Department of Conservation Te Papa Atawhai PATTERN - FACE GRAIN /1 TO BEARERS) POLYSTYRENE INSULATION ALUS NEW RZGULTRA BATTS USAL HARDERLEX SOFFET TE ANAU AREA LINING CHORE JOSETS AS WALL INSULATION Southland Conservancy PROTECTION FOR ENSULATION Project LUXPIDEE HUT KITCHEN EXTENSION Drawing Name EXISTENC HUT BASE DETATL CROSS SECTION SEE SHILLO Approved Date Scale 1:20 12/1/11 Tim Cross Asset No. Drawing No. Site No. 46873 6 412 EXISTING HUT - CROSS SECTION 1:20

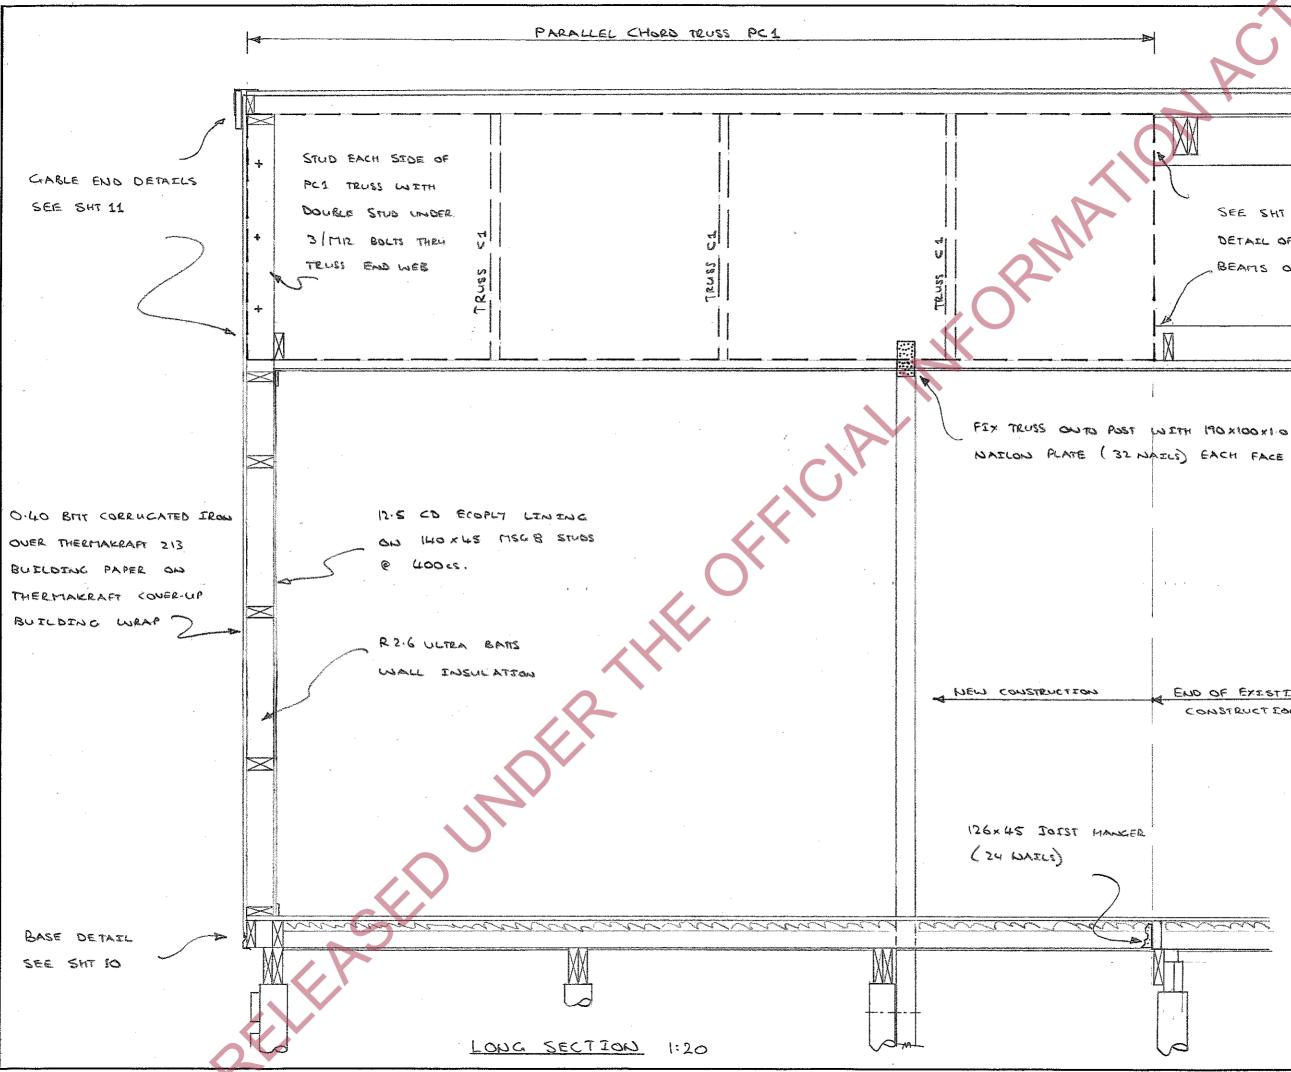



M SEE SHI 13 FOR FIXING DETAIL OF RIDGE/CEILING BEAMS ONTO TRUSS END A . . . END OF EXISTING CONSTRUCTION Department of Conservation Te Papa Atawhai 0 TE ANAU AREA Southland Conservancy Project LUXMORE HUT KITCHEN EXTENSION Drawing Name HUT EXTENSION LONG SECTION Scale Date Approved 12/1/11 1:20 Tim Cass Site No. Asset No. Drawing No. 46873 412 7

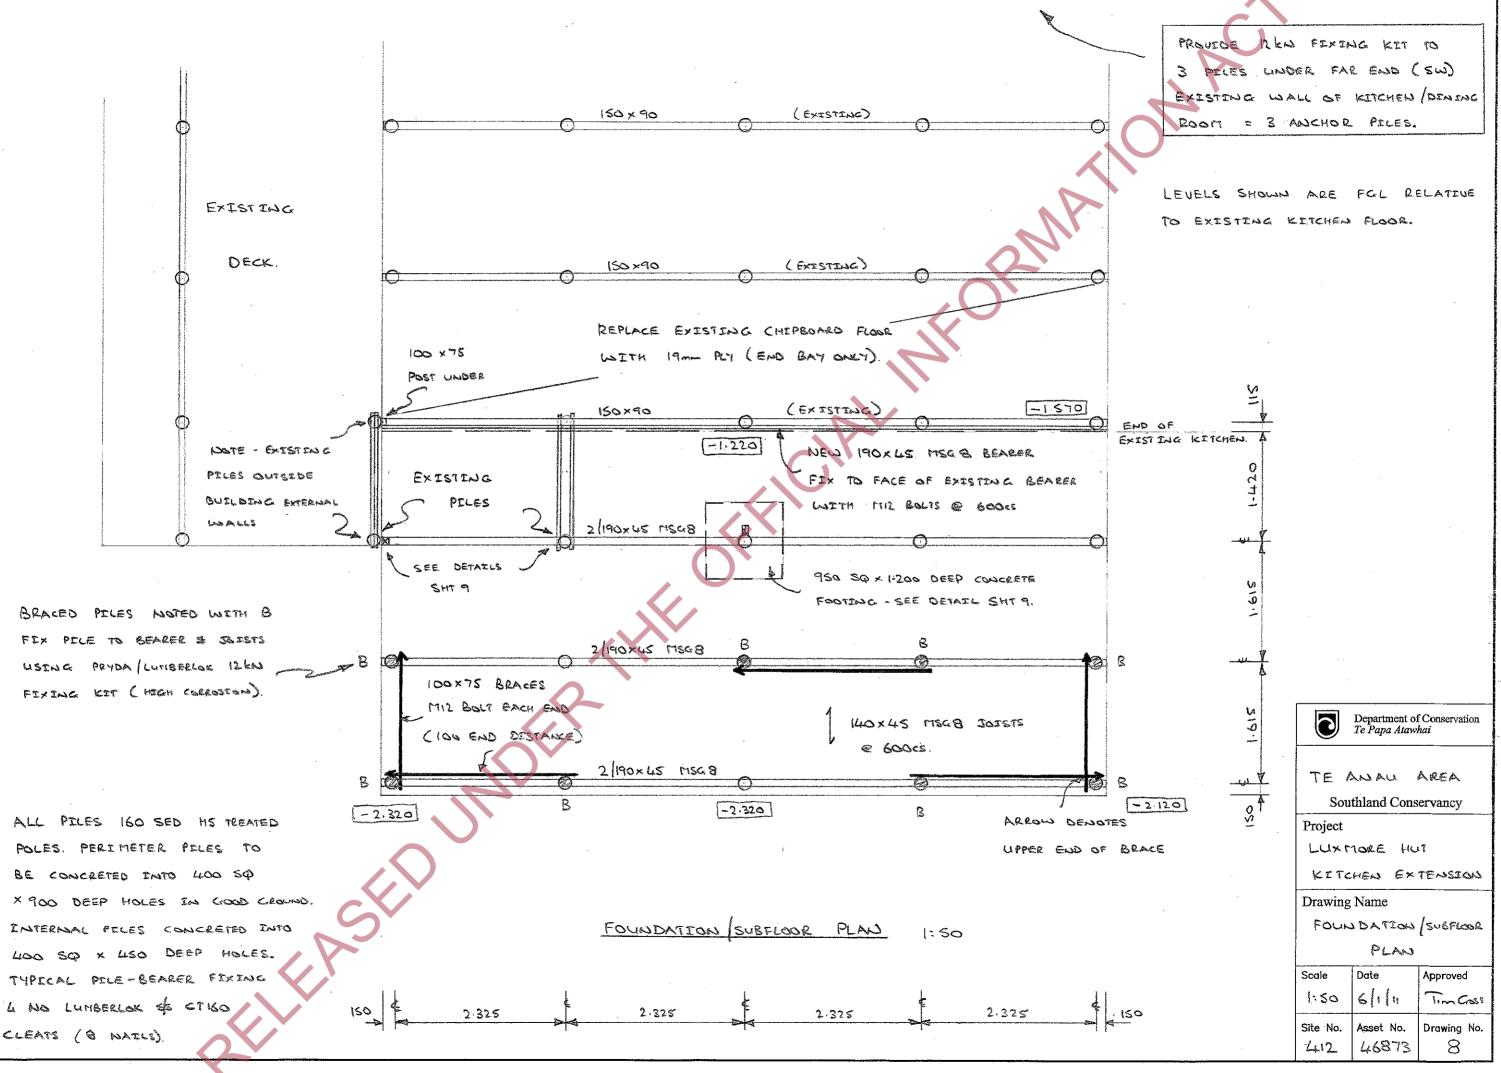

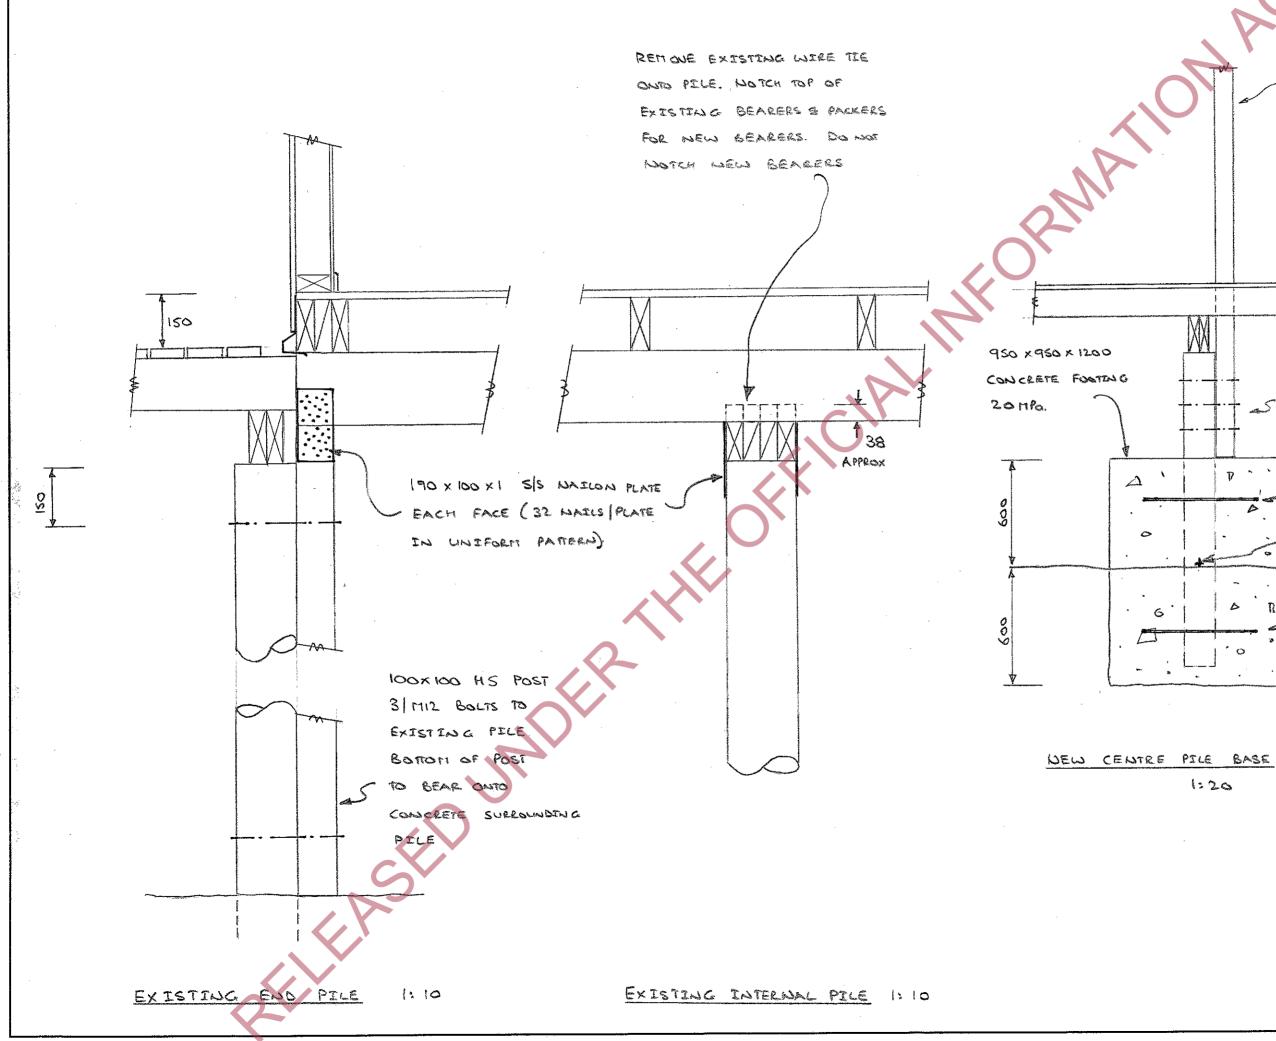



100 × 100 POST UNDER REDGE TRUSS. (H3.2 TREATED DPC UNDER BOTTOM END \mathbb{M} 3 × MIG BOLTS 160 END DISTANCE \leq 3×600 LONG GALV ~ ` 72 REIDBAR DIZ BARS A THRY PILE - FIX IN PLACE WITH 12mm REIDNUTS 6 Π 0 Department of Conservation Te Papa Atawhai 0 TE ANAU AREA Southland Conservancy 1:20 Project LUXHORE HUT KITCHEN EXTENSION. Drawing Name SUBFLOOR DETAILS Approved Scale Date 6/1/11 Tim Cross SHOWN Drawing No. Asset No. Site No. 46873 9 412

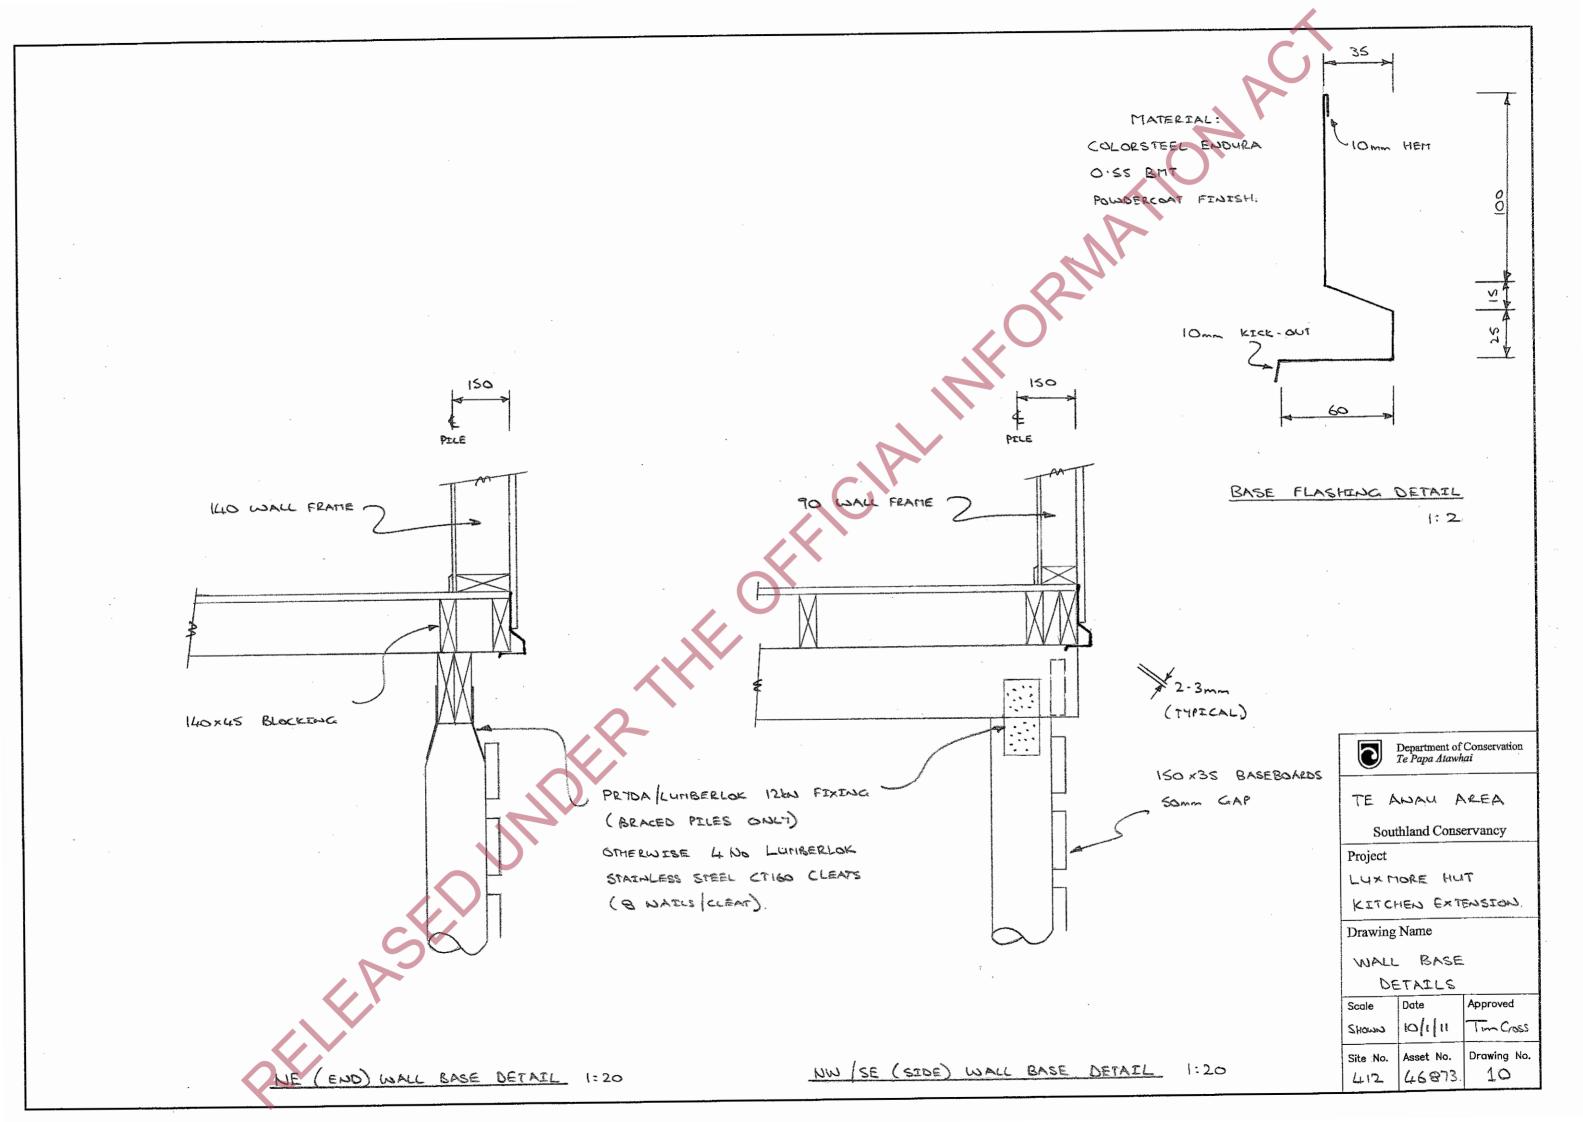

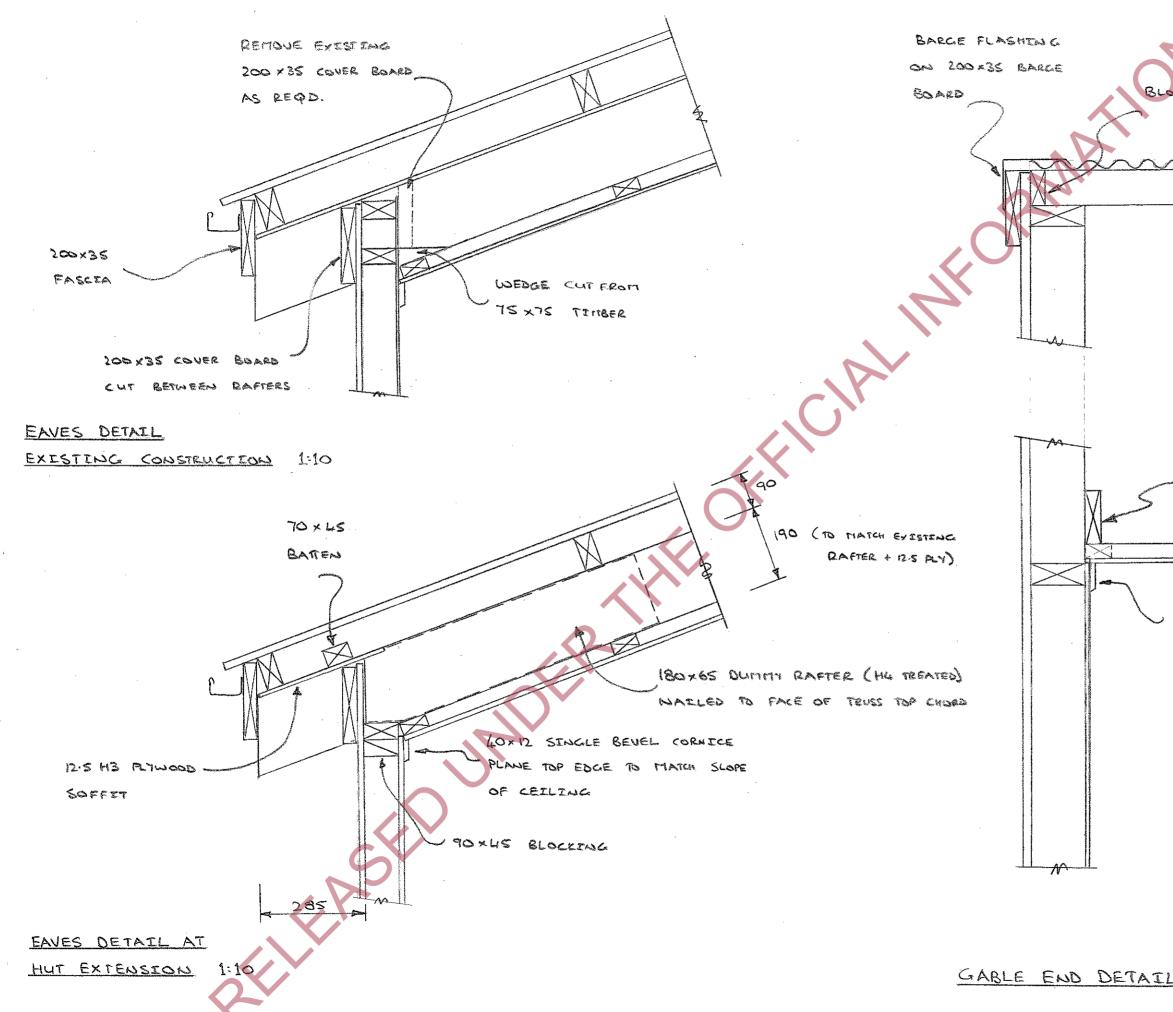


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140 x 45 MSG B	3 WALL	PLATE	
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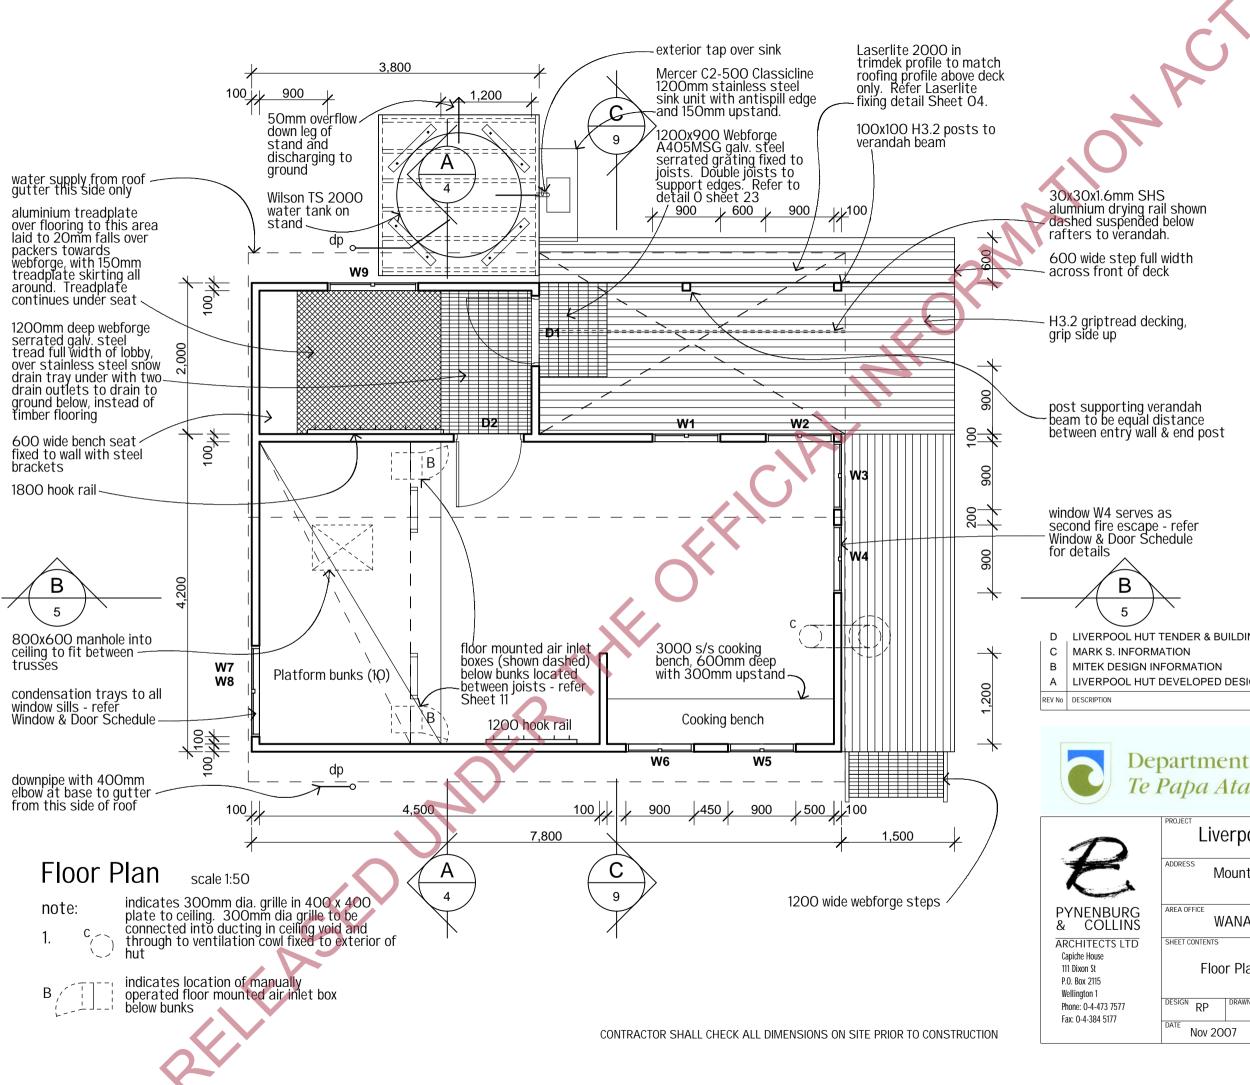


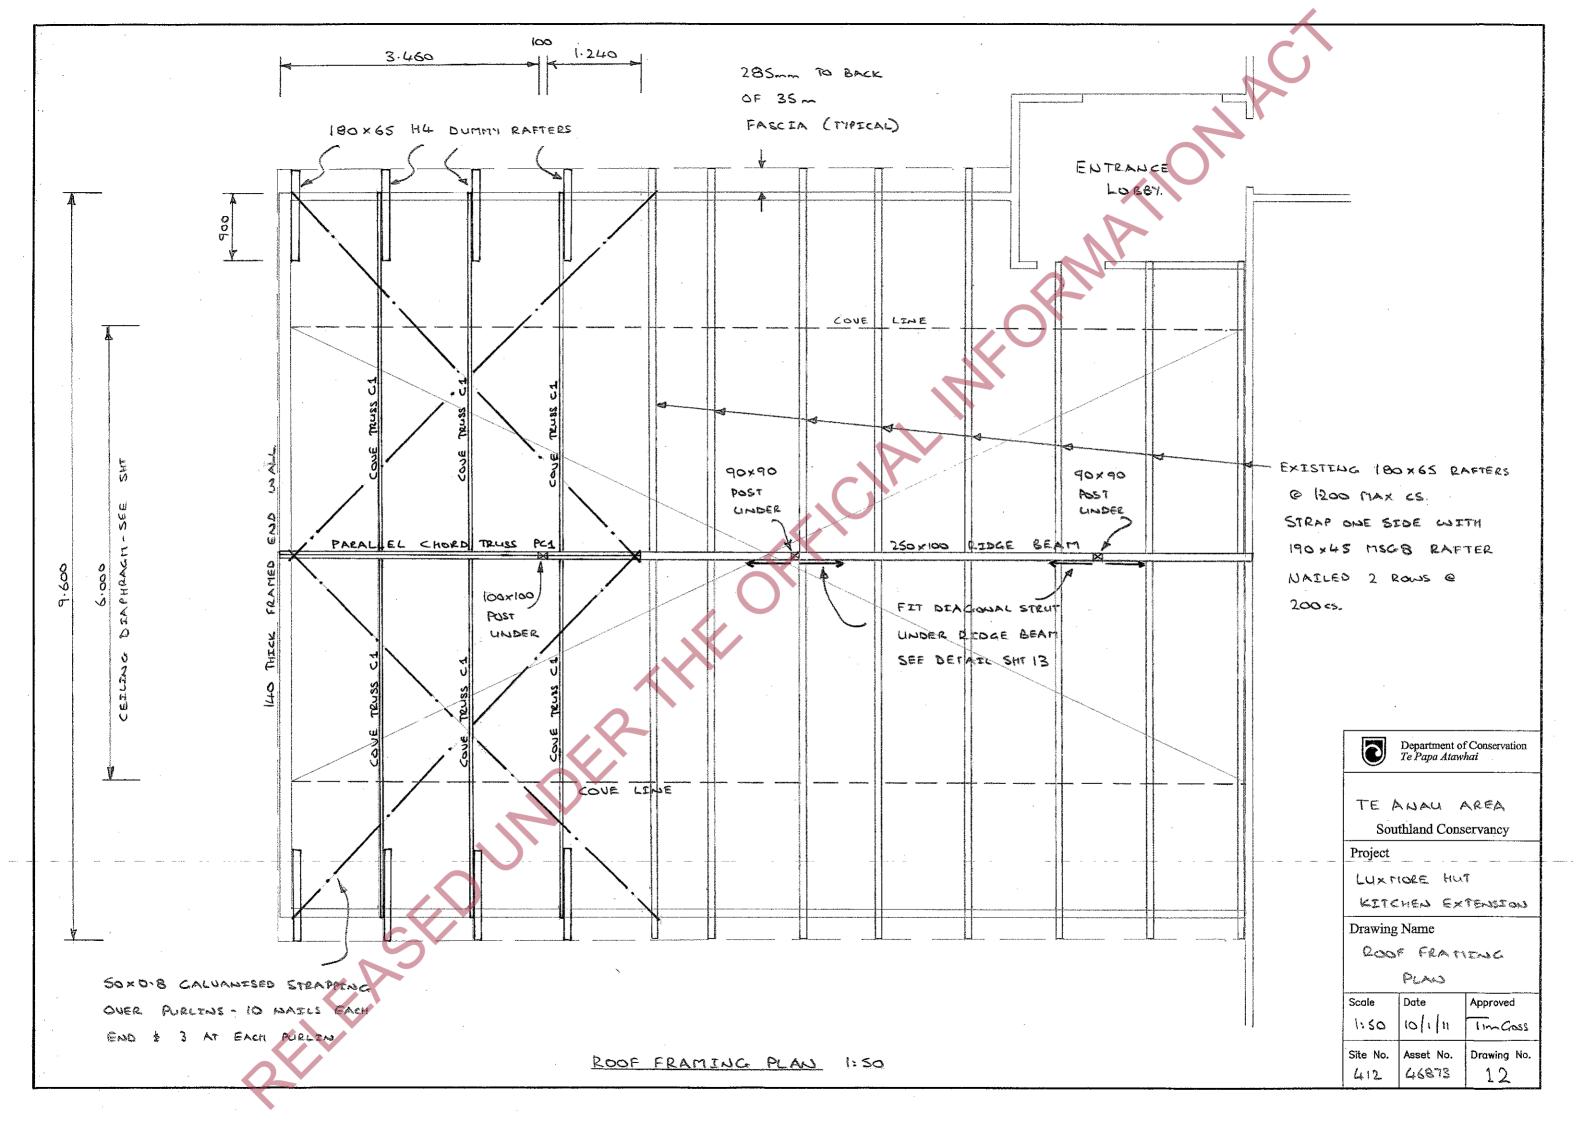190 x 45 MSG 8 PLATE FIXED TO FACE OF WALL 3/143 × 125 TYPE 17 SCREWS EACH STUD. EXTERING 30/30/30 FILEWALL I LAYER 16 FYRELENE GIG BOARD ON KITCHEN SIDE OF WALL Department of Conservation Te Papa Atawhai 0 TE ANAU AREA Southland Conservancy Project LUX MORE HUT KITCHEN EXTENSION Drawing Name ROOF FRAMENG DETAILS Approved Scale Date 10 1 11 SHOWNS Tim Coss Drawing No. Asset No. Site No. 46873 412 13

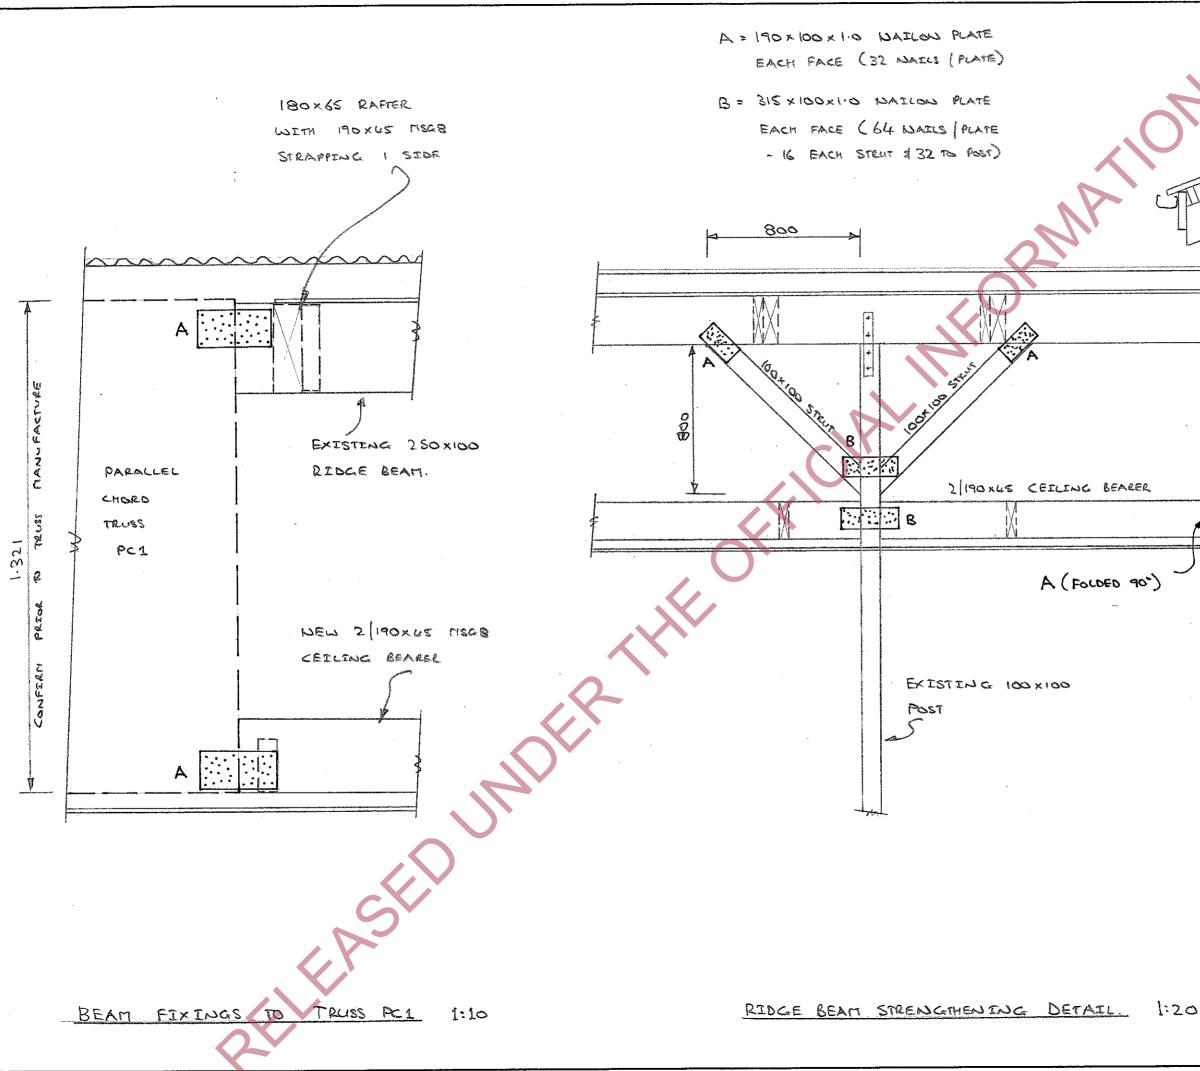

2	Liverpool Hut					
*	ADDRESS Mount Aspiring National Park					
JRG JNS	AREA OFFICE WANAKA AREA OFFICE					
LTD	SHEET CONTENTS	SCALES				
	Site plan	1:20	0			
577	DESIGN RP DRAWN RW CHECKED RP	SHEET No.	REVISION			
	Nov 2007 PROJECT No. 0743	O1R	С			

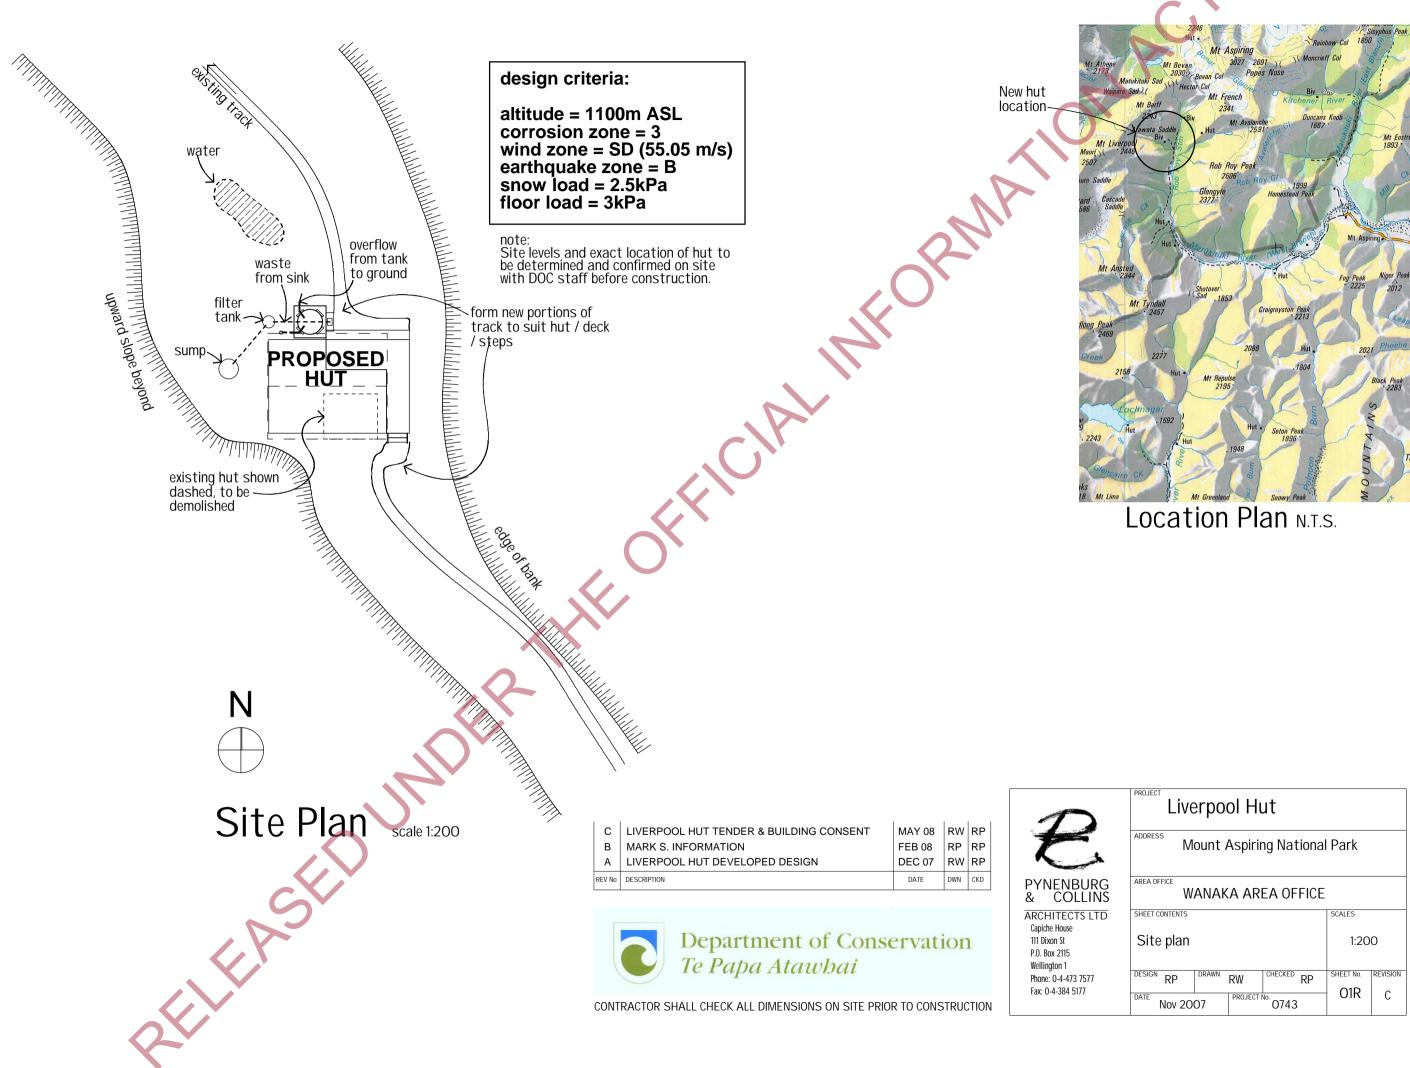Attachment 5



alumnium drying rail shown dashed suspended below

600 wide step full width across front of deck


post supporting verandah beam to be equal distance between entry wall & end post

window W4 serves as second fire escape - refer Window & Door Schedule

В 5

OOL HUT TENDER & BUILDING CONSENT	MAY 08	RW	RP	
INFORMATION	FEB 08	RP	RP	
ESIGN INFORMATION	JAN 08	RP	RP	
OOL HUT DEVELOPED DESIGN	DEC 07	RW	RP	
	DATE	DWN	CKD	

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JRG .INS	AREA OFFICE				
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	Floor Plan	1:50			
77	DESIGN RP DRAWN RW CHECKED RP	SHEET No.	REVISION		
	DATE Nov 2007 PROJECT No. 0743	O2R	D		

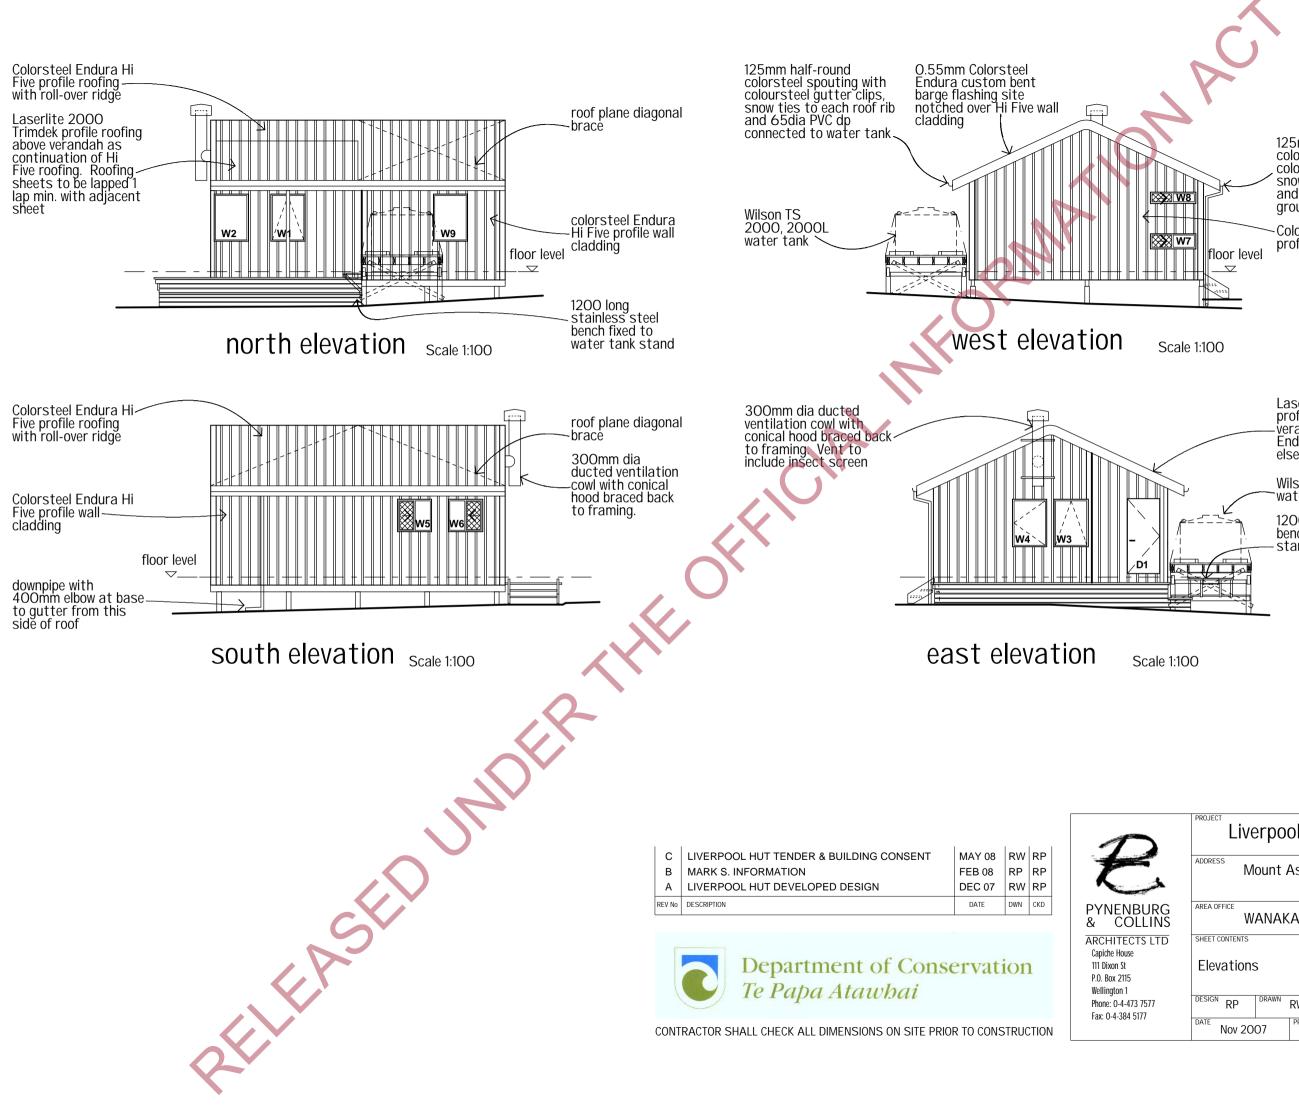

125mm half-round colorsteel spouting with coloursteel gutter clips, snow ties to each roof rib and 65dia PVC dp to ground with 400mm elbow


Colorsteel Endura Hi Five profile wall cladding

Laserlite 2000 Trimdek profile roofing above -verandah only, Colorsteel Endura Hi Five roofing elsewhere


Wilson TS 2000, 2000L water tank

1200 long stainless steel bench fixed to water tank stand


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	DATE Nov 2007 PROJECT No. 0743	CO3R C			

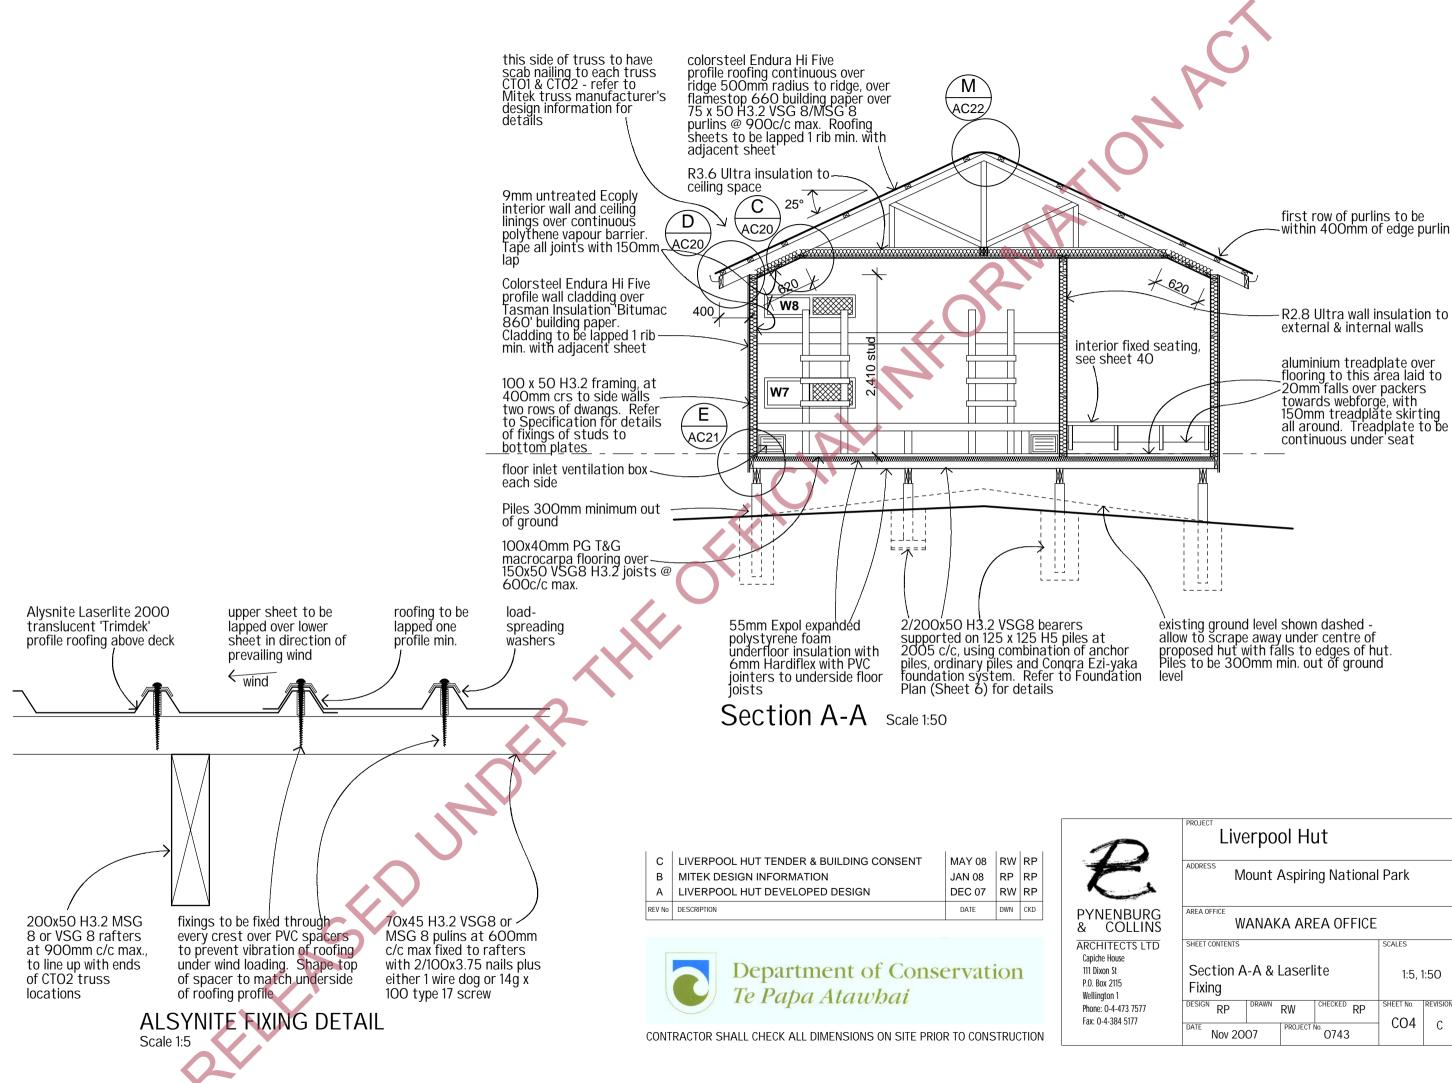


>	Liverpool Hut					
	ADDRESS Mount Aspiring National Park					
JRG LINS	AREA OFFICE					
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	Section A-A & La Fixing		1:5, 1:50			
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7	DATE Nov 2007	COJECT NO. 0743	CO4 c			

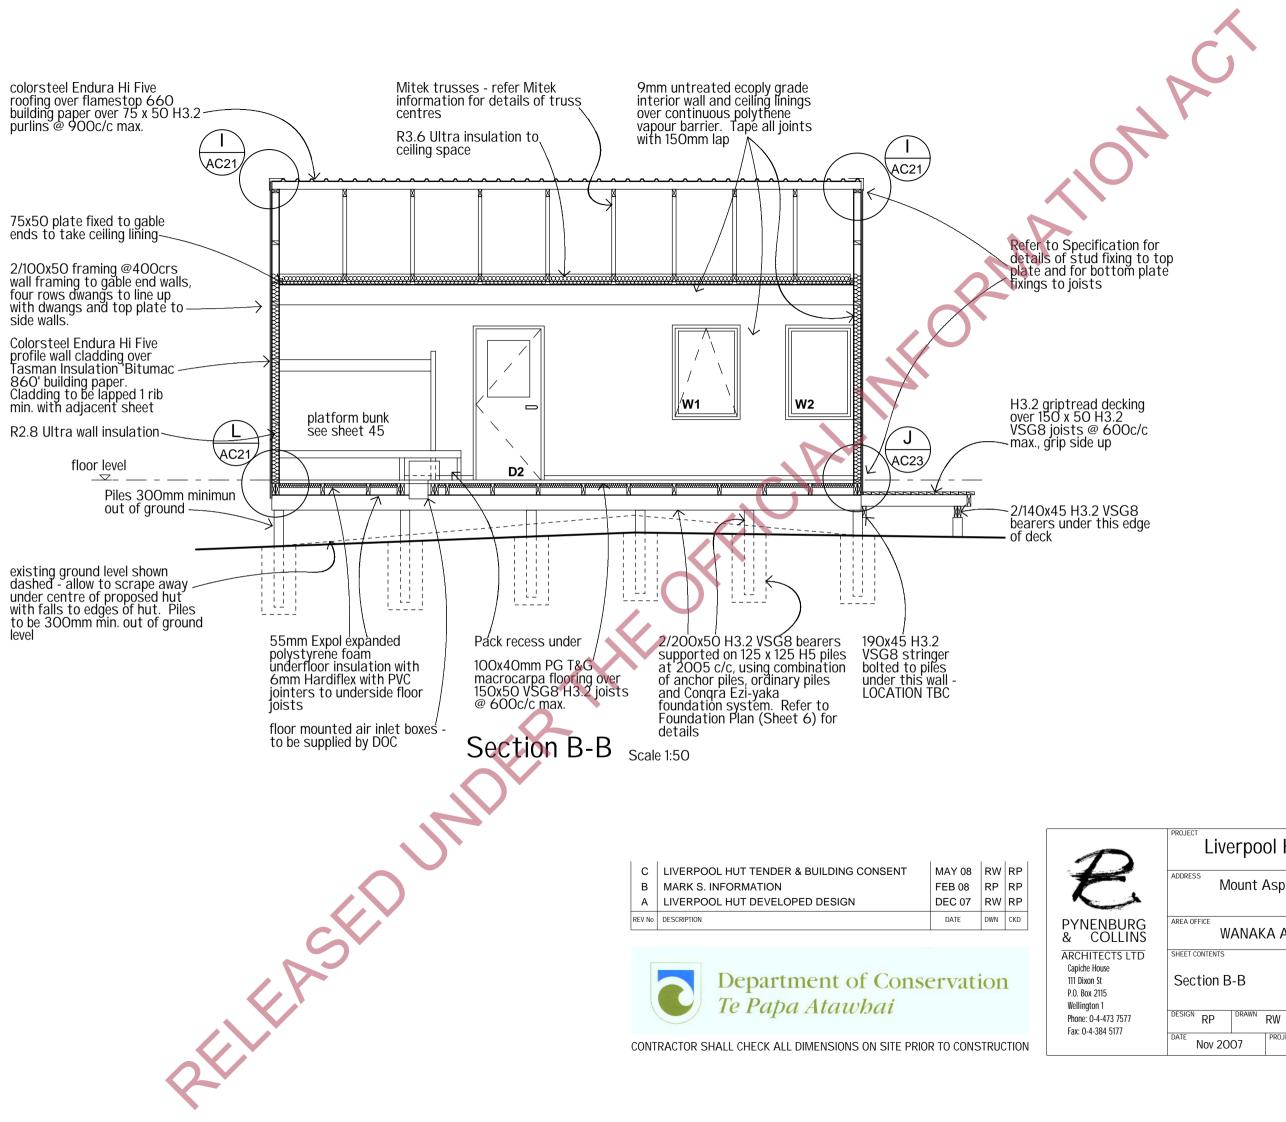

>	Liverpo	ol Hut			
*	ADDRESS Mount Aspiring National Park				
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77		RW CHECKED RP	SHEET NO. REVISION		
	Nov 2007	PROJECT No. 0743	COSR C		

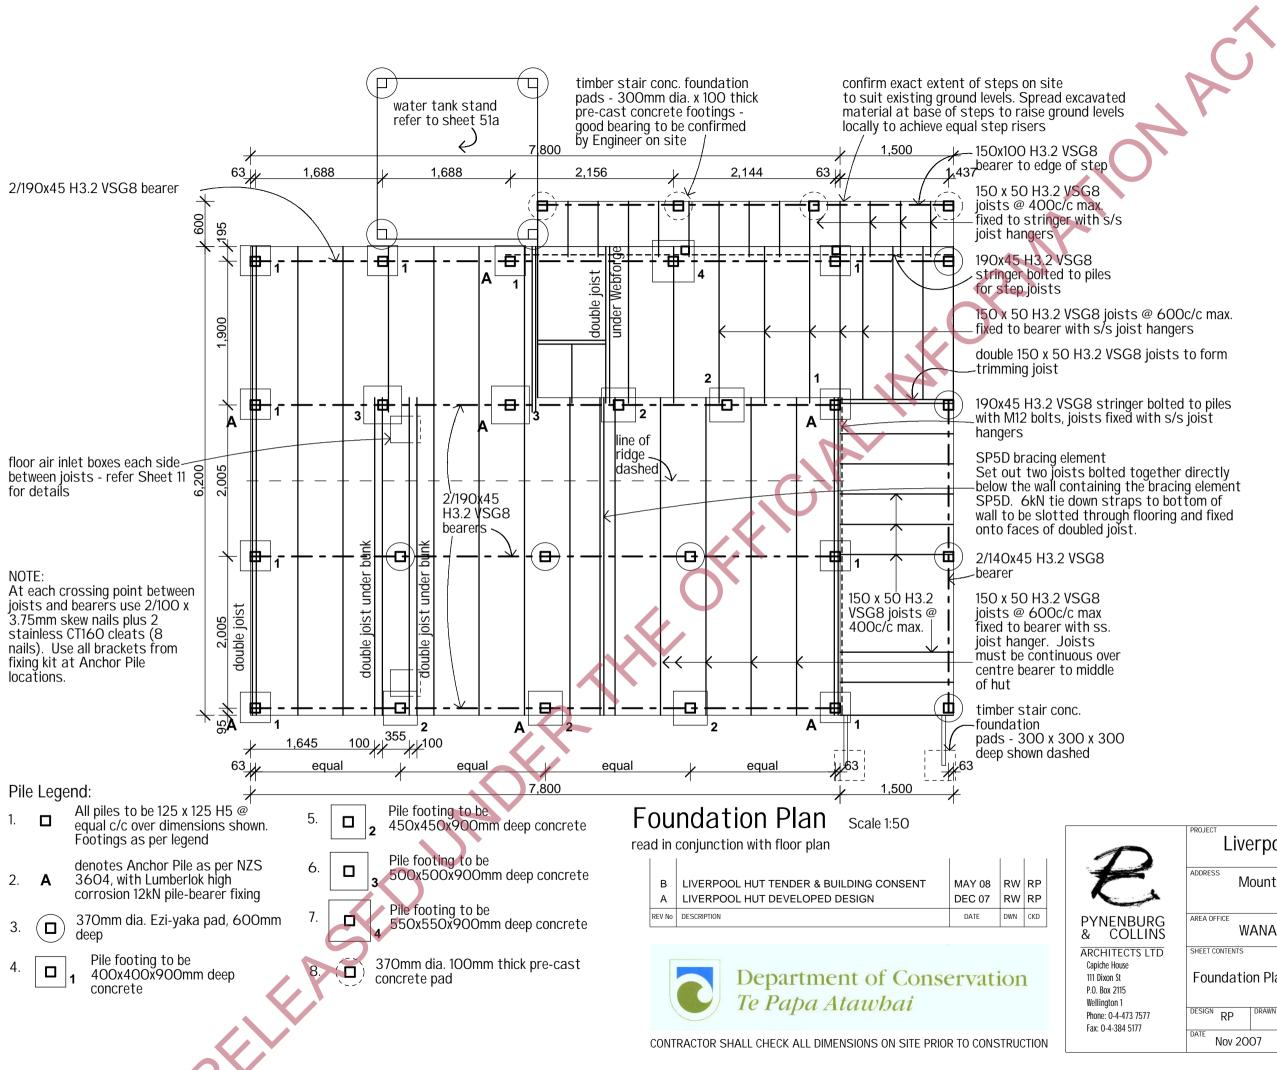

Liverpool Hut				
ADDRESS Mount Aspiring National Park				
AREA OFFICE WANAKA AREA OFFIC	E			
SHEET CONTENTS	SCALES			
Foundation Plan	1:50			
DESIGN RP DRAWN RW CHECKED RP	SHEET NO. REVISION			
	Liverpool Hut ADDRESS Mount Aspiring Nation AREA OFFICE WANAKA AREA OFFIC SHEET CONTENTS Foundation Plan DESIGN RP DRAWN RW CHECKED RP			

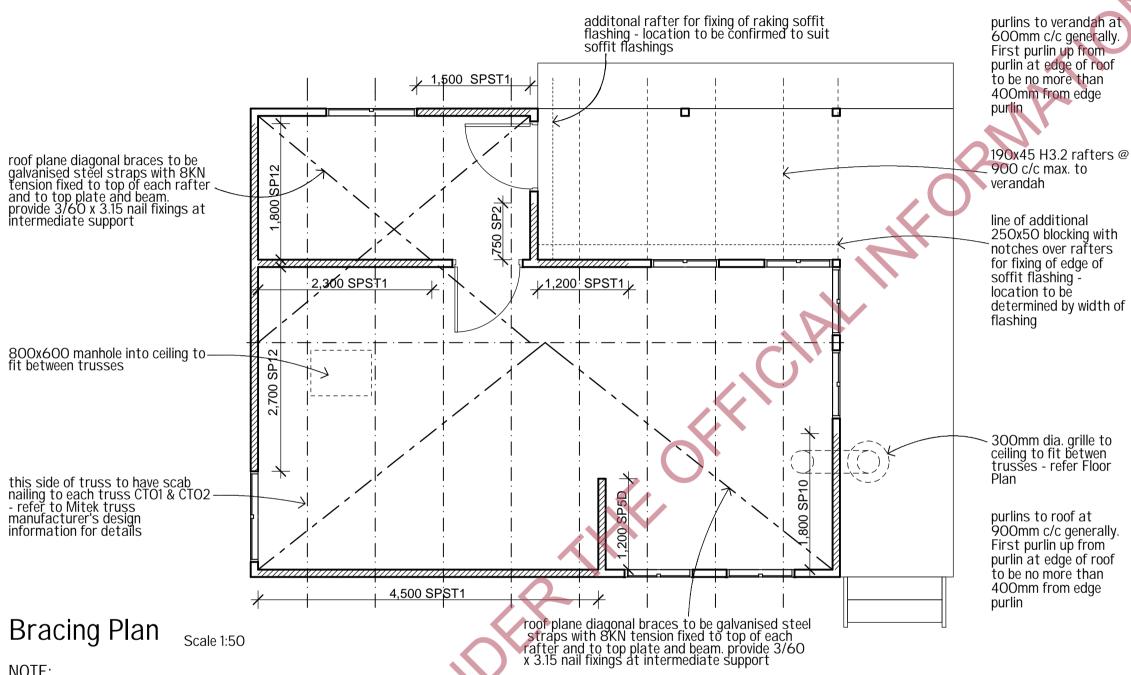

NOTE:

Connection of top plate and bottom plate to wall framing on the longitudinal walls (east-west) to be SBS400 sheet brace strap (25x1.0 400mm long strap) looped over plate and fixed to each outside face of stud with 4 nails each end. Strap detail required every second stud (800mm c/c max.), adjacent to truss positions, at both the top and bottom of the wall'. All other connections between top plates and walls to be in accordance with NZS3604:1999. Connect bottom plate directly to floor joists on longitudinal walls using 2 14g x 100 Type 17 screws at 600mm c/c max. directly into each joist. Requirements for fixing of bracing elements are additional to these fixings. 1. elements are additional to these fixings.

Connection of top plate to study on the transverse walls (north-south) to be 1 U-nail every stud (400mm c/c max.).

Ecoply wall bracing elements shown. Refer to Engineer's calculations and manufacturer's literature in 2. Specification for bracing types, length, height and connections.

В	LIVERPOOL HUT TENDER & BUILDING CONSENT	MAY 08	RW	RP
A	LIVERPOOL HUT DEVELOPED DESIGN	DEC 07	RW	RP
REV No	DESCRIPTION	DATE	DWN	CKD



PRO IE

ARCHITECTS I Capiche House 111 Dixon St P.O. Box 2115 Wellington 1 Phone: 0-4-473 757 Fax: 0-4-384 5177


CONTRACTOR SHALL CHECK ALL DIMENSIONS ON SITE PRIOR TO CONSTRUCTION

Te Papa Atawhai

Department of Conservation

2	Liverpool Hut		
.	ADDRESS Mount Aspiring National	Park	
RG NS	AREA OFFICE WANAKA AREA OFFICE		
TD	SHEET CONTENTS	SCALES	
	Bracing Plan		
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	DATE Nov 2007 PROJECT No. 0743	07R	В




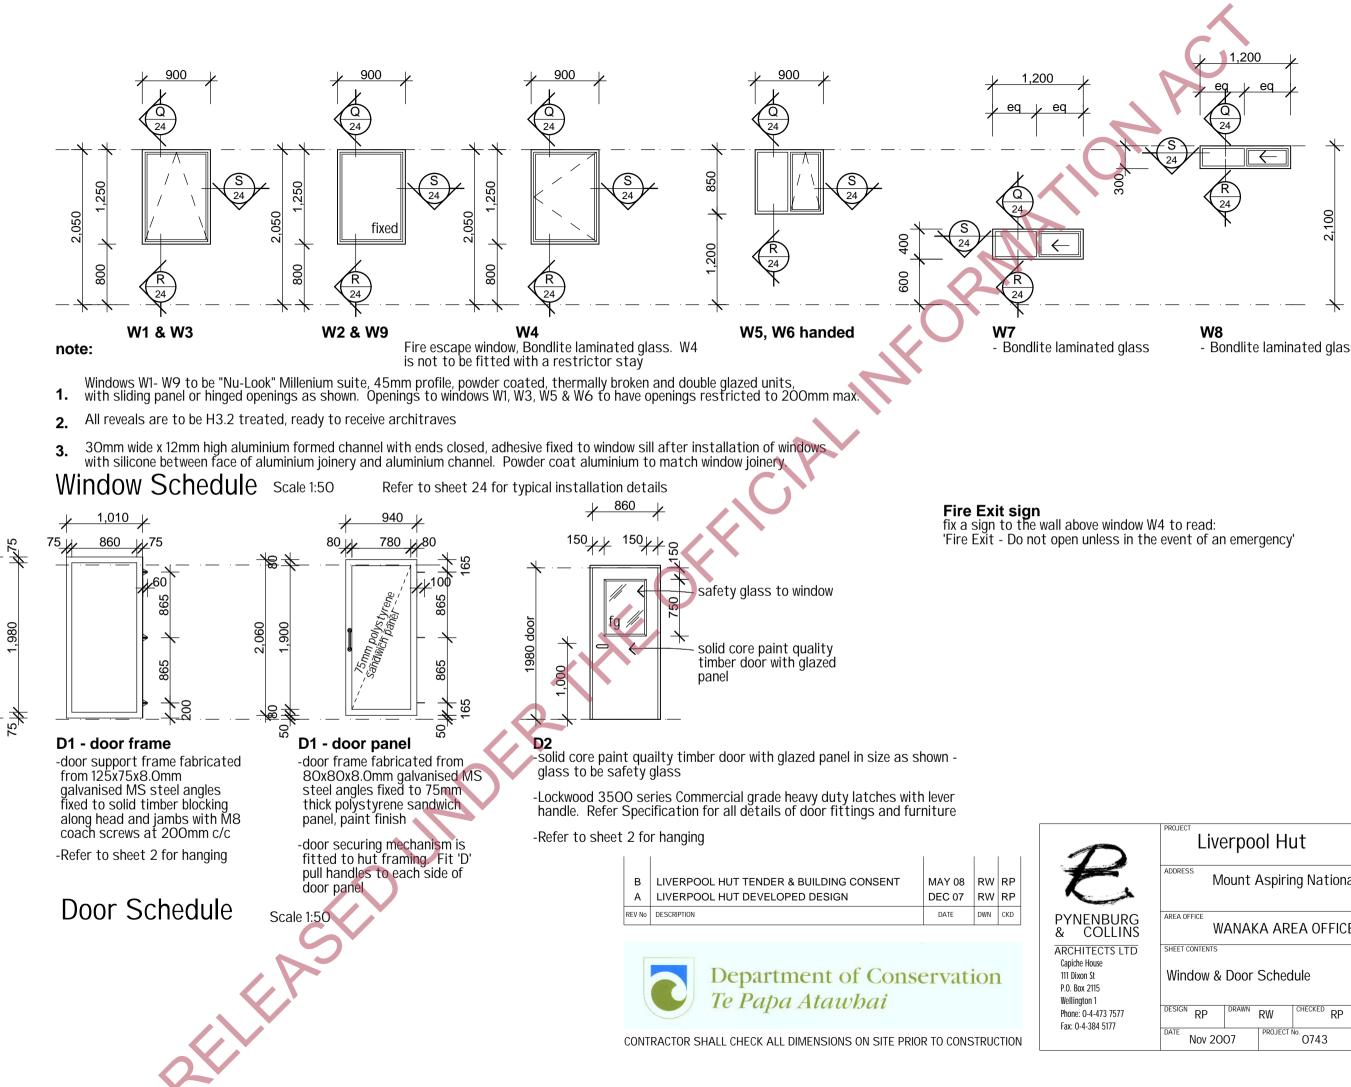


2,130

- Bondlite laminated glass


>	Liverpool Hut					
	ADDRESS Mount Aspiring National Park					
JRG JNS	AREA OFFICE					
LTD	SHEET CONTENTS Window & Door Schedule	SCALES				
577	DESIGN RP DRAWN RW CHECKED RP DATE Nov 2007 PROJECT NO. 0743	SHEET No.	REVISION B			

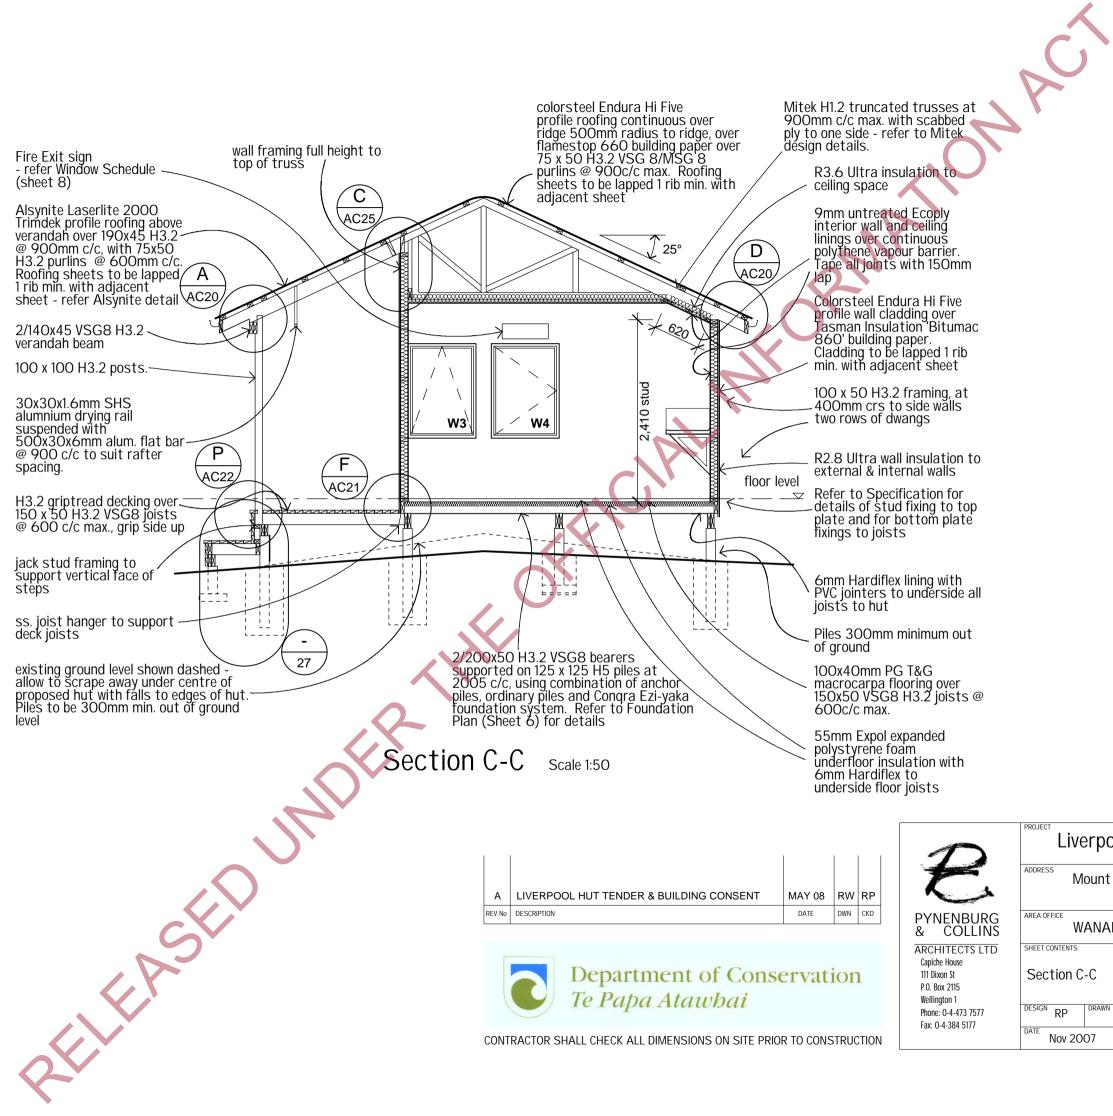

2	Liverpool Hut				
*	ADDRESS Mount Aspiring National Park				
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	Section C-C		1:50		
17	DESIGN RP DRAWN		SHEET No.		
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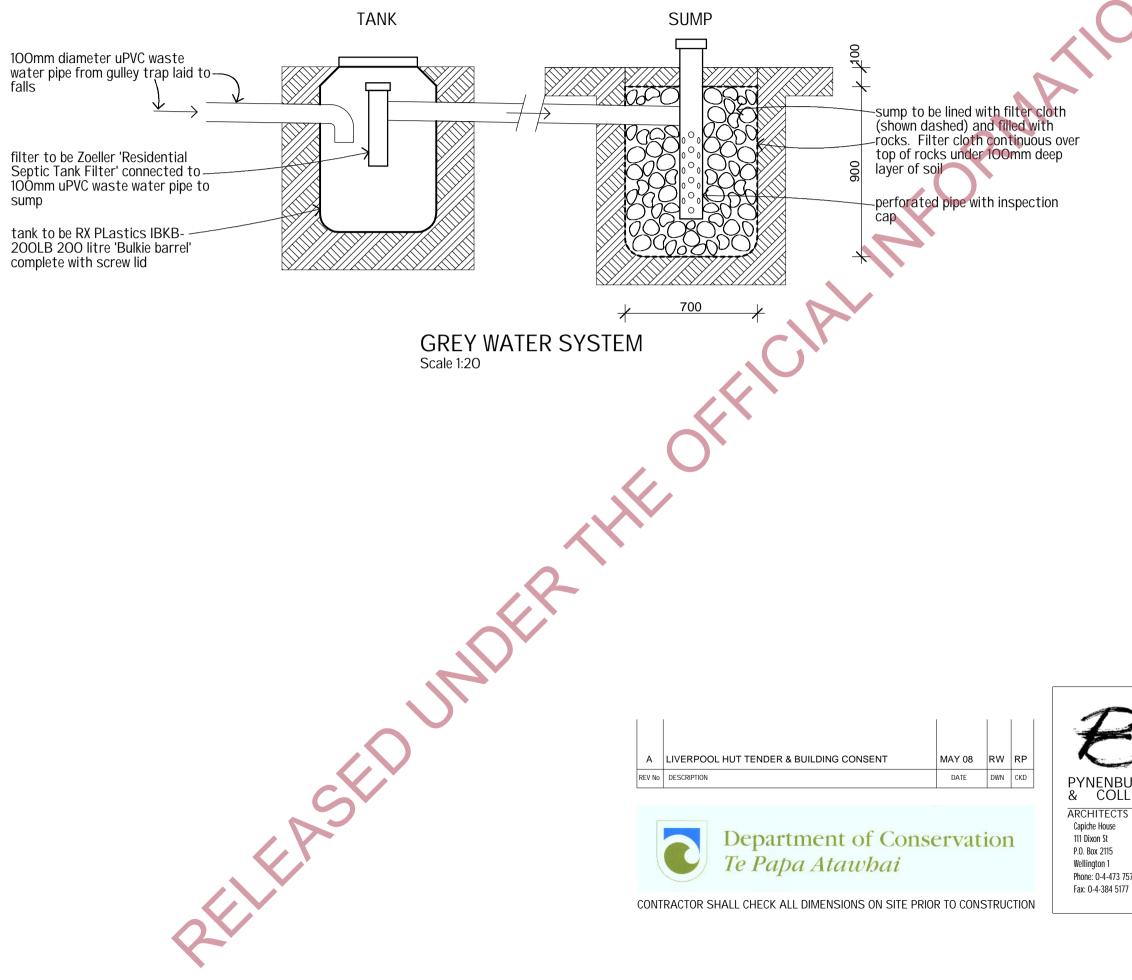


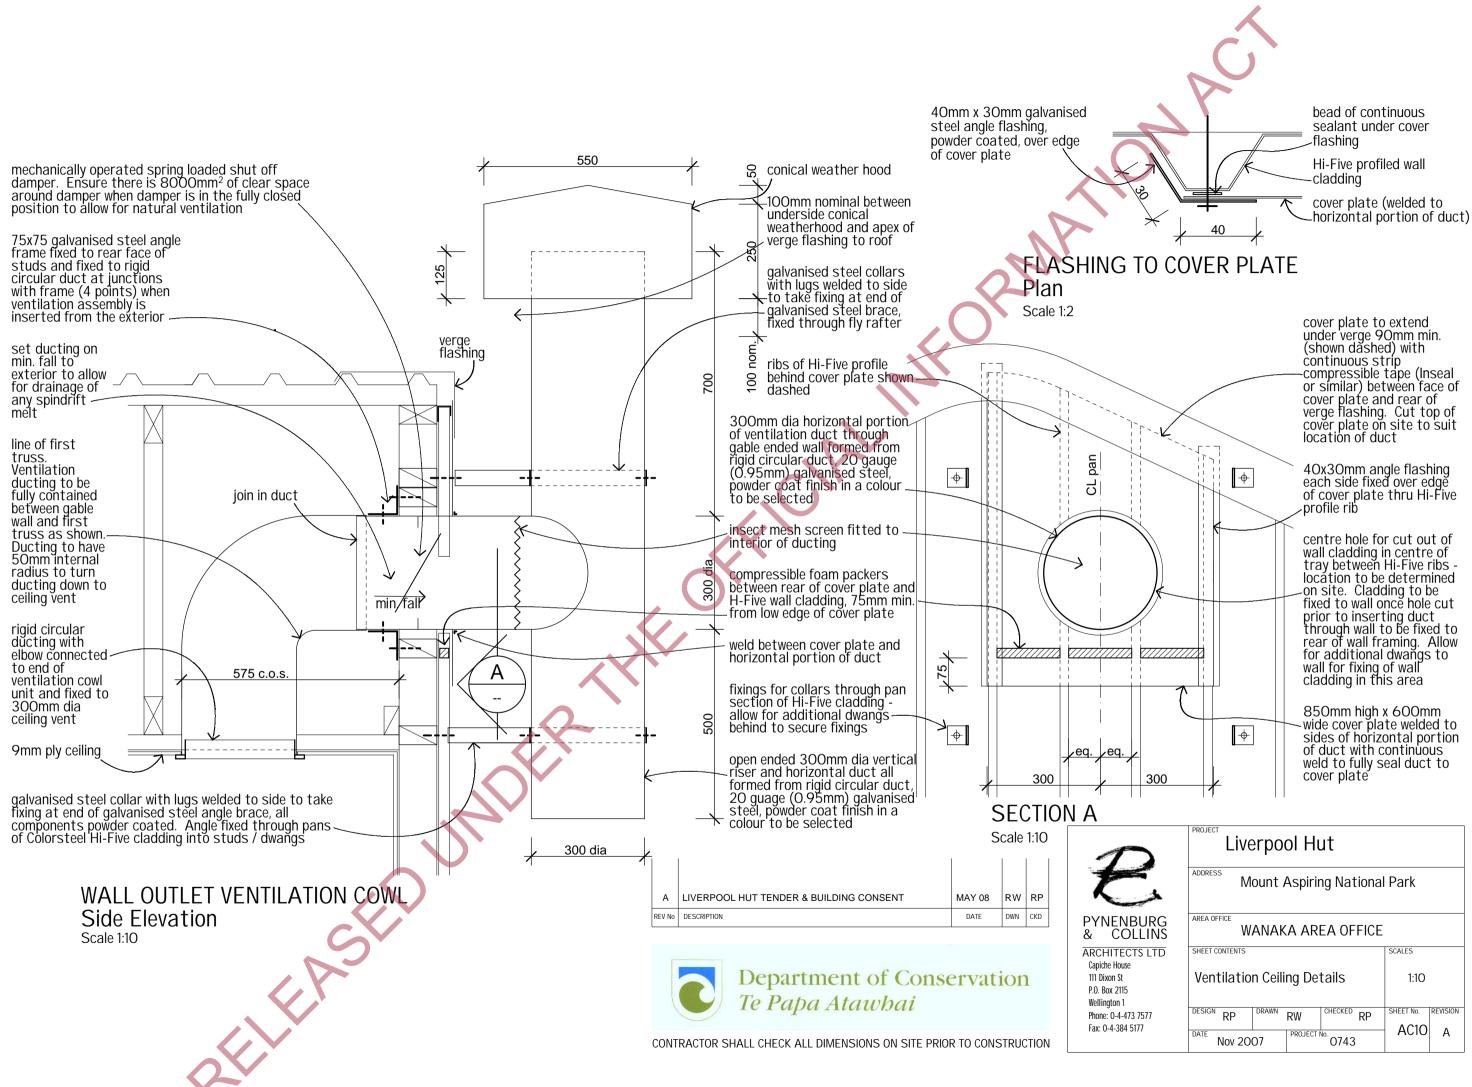2	Liverpool Hut					
	ADDRESS Mount Aspiring National Park					
URG LINS	AREA OFFICE WANAKA AREA OFFICE					
s ltd	SHEET CONTENTS	SCALES				
	Ventilation Ceiling Details	1:10				
'577 7	DESIGN RP DRAWN RW CHECKED RP	SHEET No. REVISION				
1	DATE Nov 2007 PROJECT No. 0743	AC10 A				

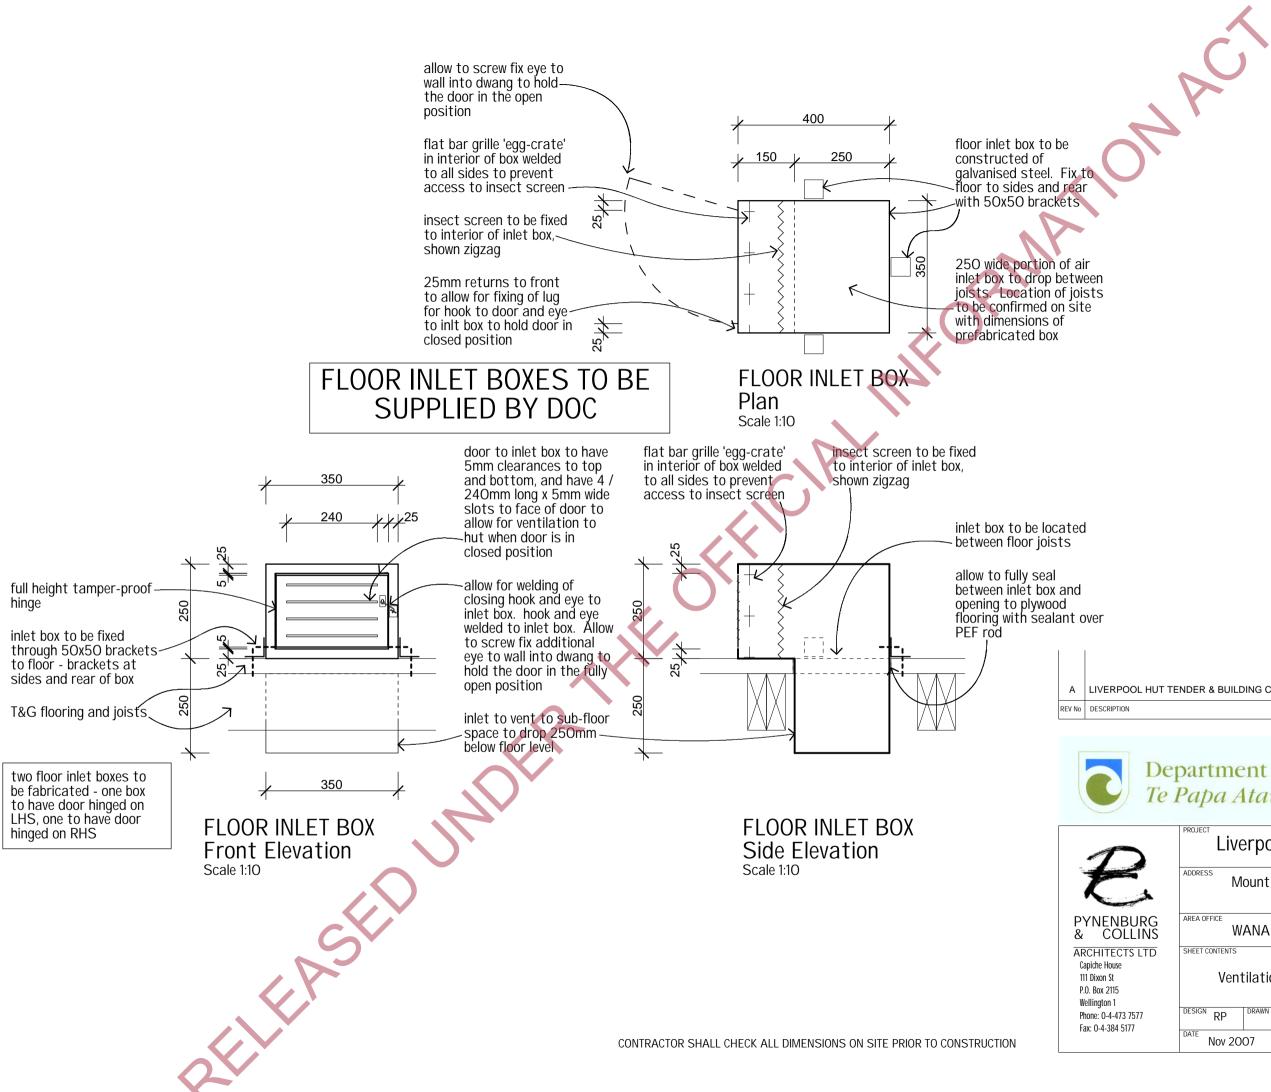


DL HUT TENDER & BUILDING CONSENT	MAY 08	RW	RP	
	DATE	DWN	CKD	

	Liverpool Hut					
	ADDRESS Mount Aspiring National Park					
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	Ventilation Floor Details	5 1:10				
577	DESIGN RP DRAWN RW CHECKED RP	SHEET No. REVISION				
1	DATE Nov 2007 PROJECT No. 0743	— AC11 A				



2	Liverpc	ol H	ut		
4	ADDRESS Mount Aspiring National Park				
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	Grey water sys	stem		1:20	
17	DESIGN RP	RW	CHECKED RP	SHEET No.	REVISION
	DATE Nov 2007	PROJECT	^{No.} 0743	12	А



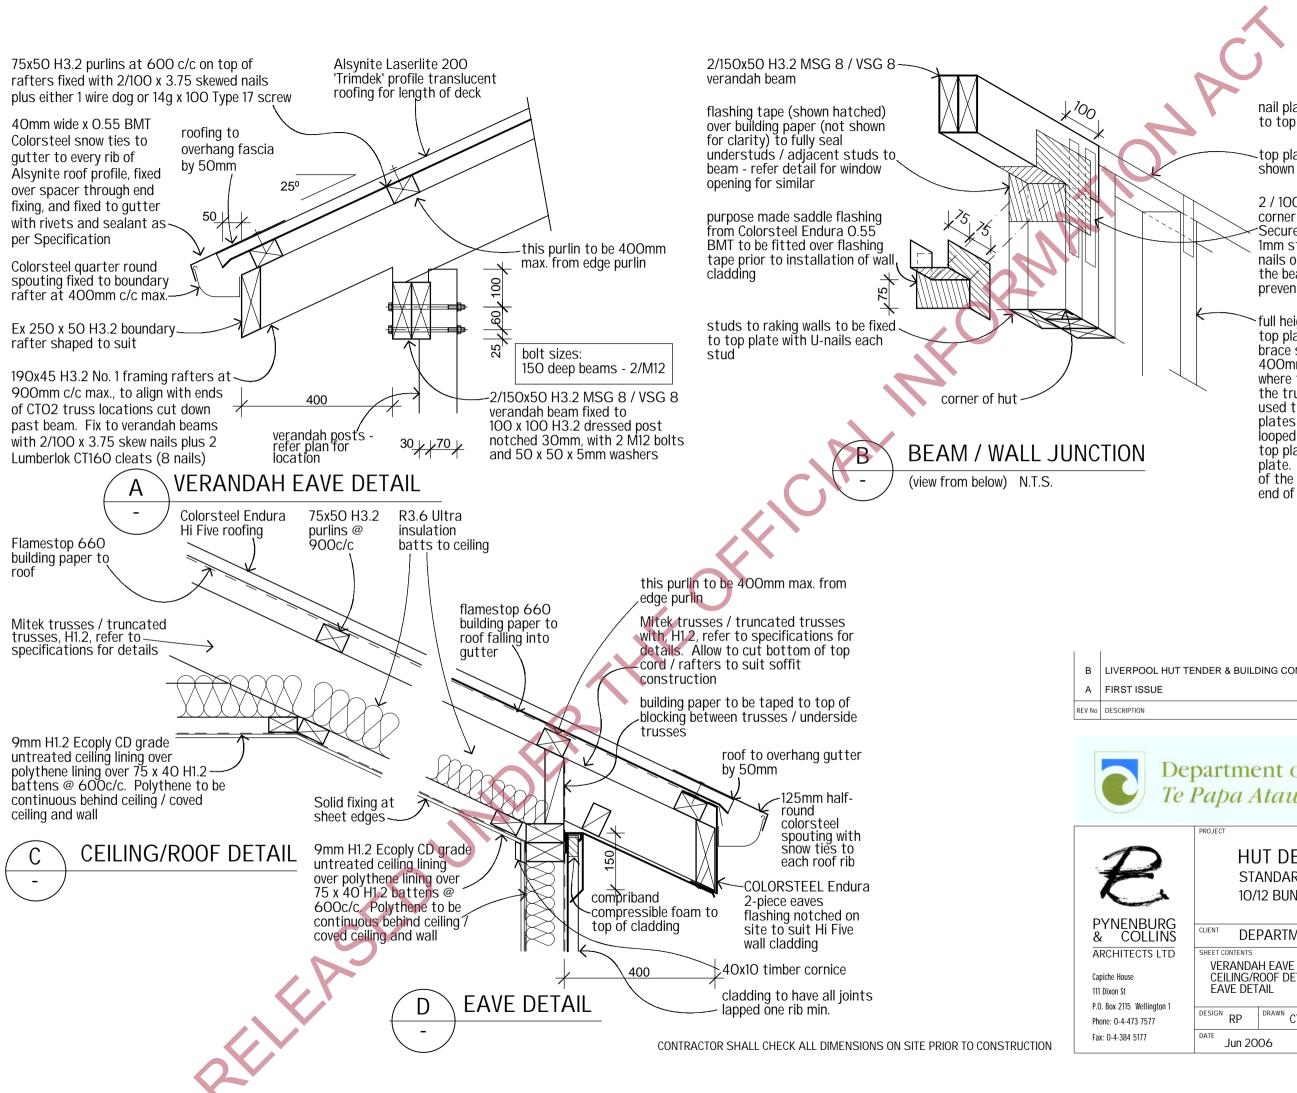

nail plates to connect top plates to top of beam (not shown)


top plate in longtiudinal direction shown

2 / 100 x 50mm understuds to corner fixed to verandah beam. Secure against uplift with 25 x 1mm strap with 6/30 x 2.5mm nails on one side only into both the beam and understuds to prevent uplift

full height stud to wall fixed to top plate with SBS400 sheet brace strap (25 x 1.0mm by 400mm long) at 800mm c/c, where the studs are adjacent to the trusses over. Straps to be used to both top and bottom plates and straps are to be looped from the studs over the top plate / under the bottom plate. Fix to the outside faces of the studs with 4 nails each end of strap


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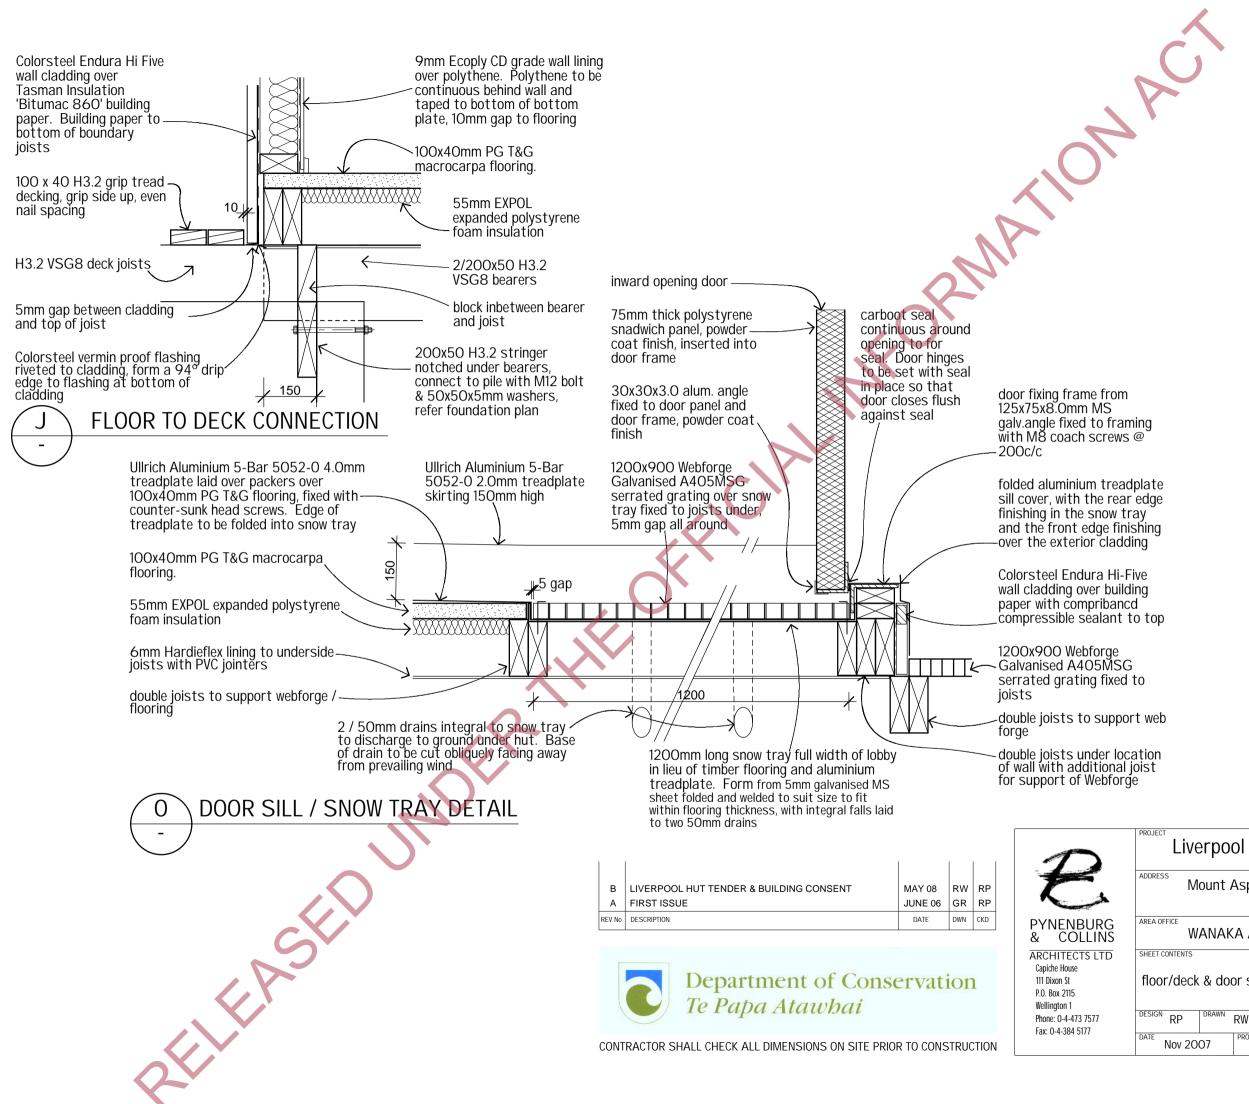
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0 2 1 2	FLOOR DETAIL FLOOR TO DECK DETAIL BOUNDARY JOIST & VERGE DETAIL			1:10	
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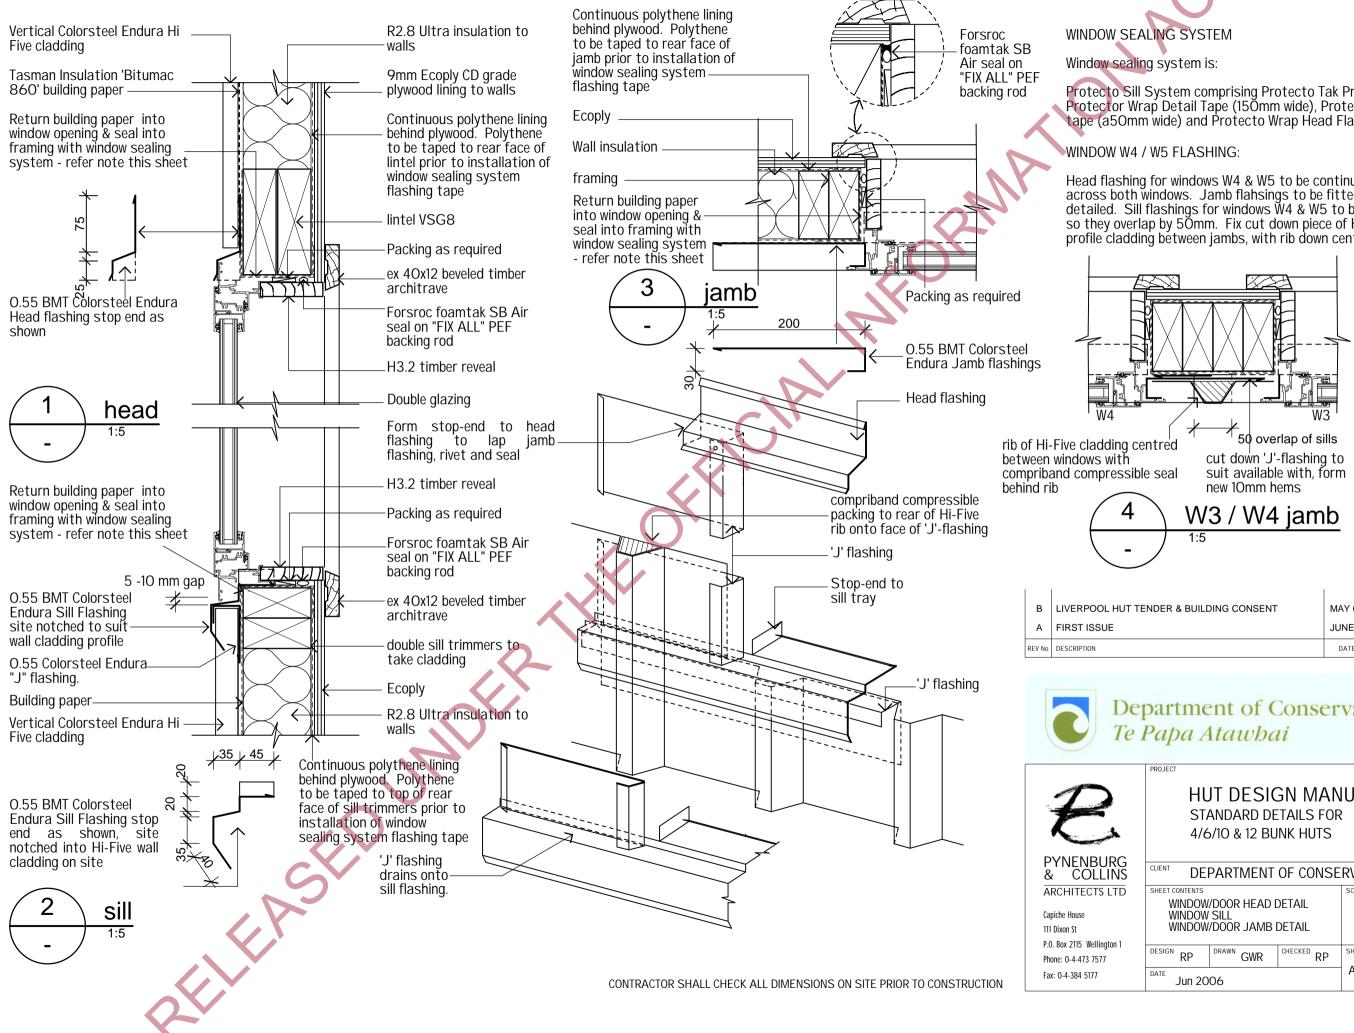


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STA	ANDARD DE	TAILS FOR		
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SHEET CONTENTS FLOOR TO DECK CONNECTION EXTERNAL CORNER FLASHING DOOR SILL & POST CONNECTION			scales 1:10	
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	CLIENT DEF SHEET CONTENTS FLOOR TI EXTERNA DOOR SI DESIGN RP DATE	HUT DESIC STANDARD DE 10/12 BUNK HU	HUT DESIGN MAN STANDARD DETAILS FOR 10/12 BUNK HUTS CLIENT DEPARTMENT OF CONSE SHEET CONTENTS FLOOR TO DECK CONNECTION EXTERNAL CORNER FLASHING DOOR SILL & POST CONNECTION DESIGN RP DRAWN CT CHECKED RP	HUT DESIGN MANUAL STANDARD DETAILS FOR 10/12 BUNK HUTS CLIENT DEPARTMENT OF CONSERVATION SCALES FLOOR TO DECK CONNECTION EXTERNAL CORNER FLASHING DOOR SILL & POST CONNECTION DESIGN RP DESIGN DRAWN CT CHECKED RP AC22a

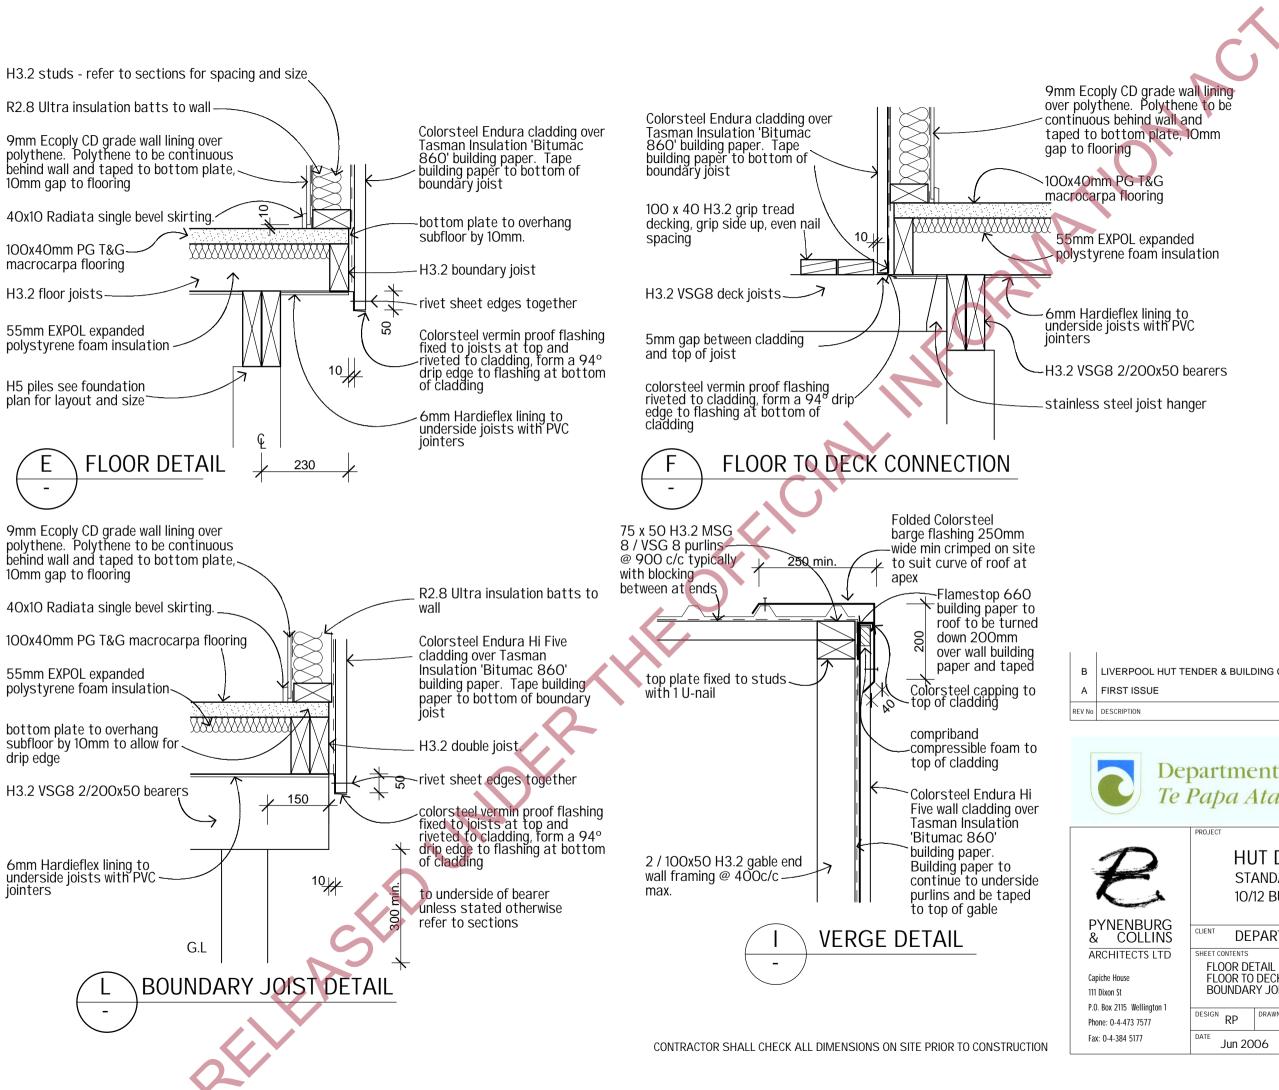

	ADDRESS Mount Aspiring National Park					
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IRG INS	AREA OFFICE	A AREA OFFICE				
LTD	SHEET CONTENTS		SCALES			
	floor/deck & doo	or sill / tray	1:10			
77	DESIGN RP	RW CHECKED RP	SHEET No. REVISION			
	DATE NOV 2007	PROJECT No. 0743	AC23a _B			



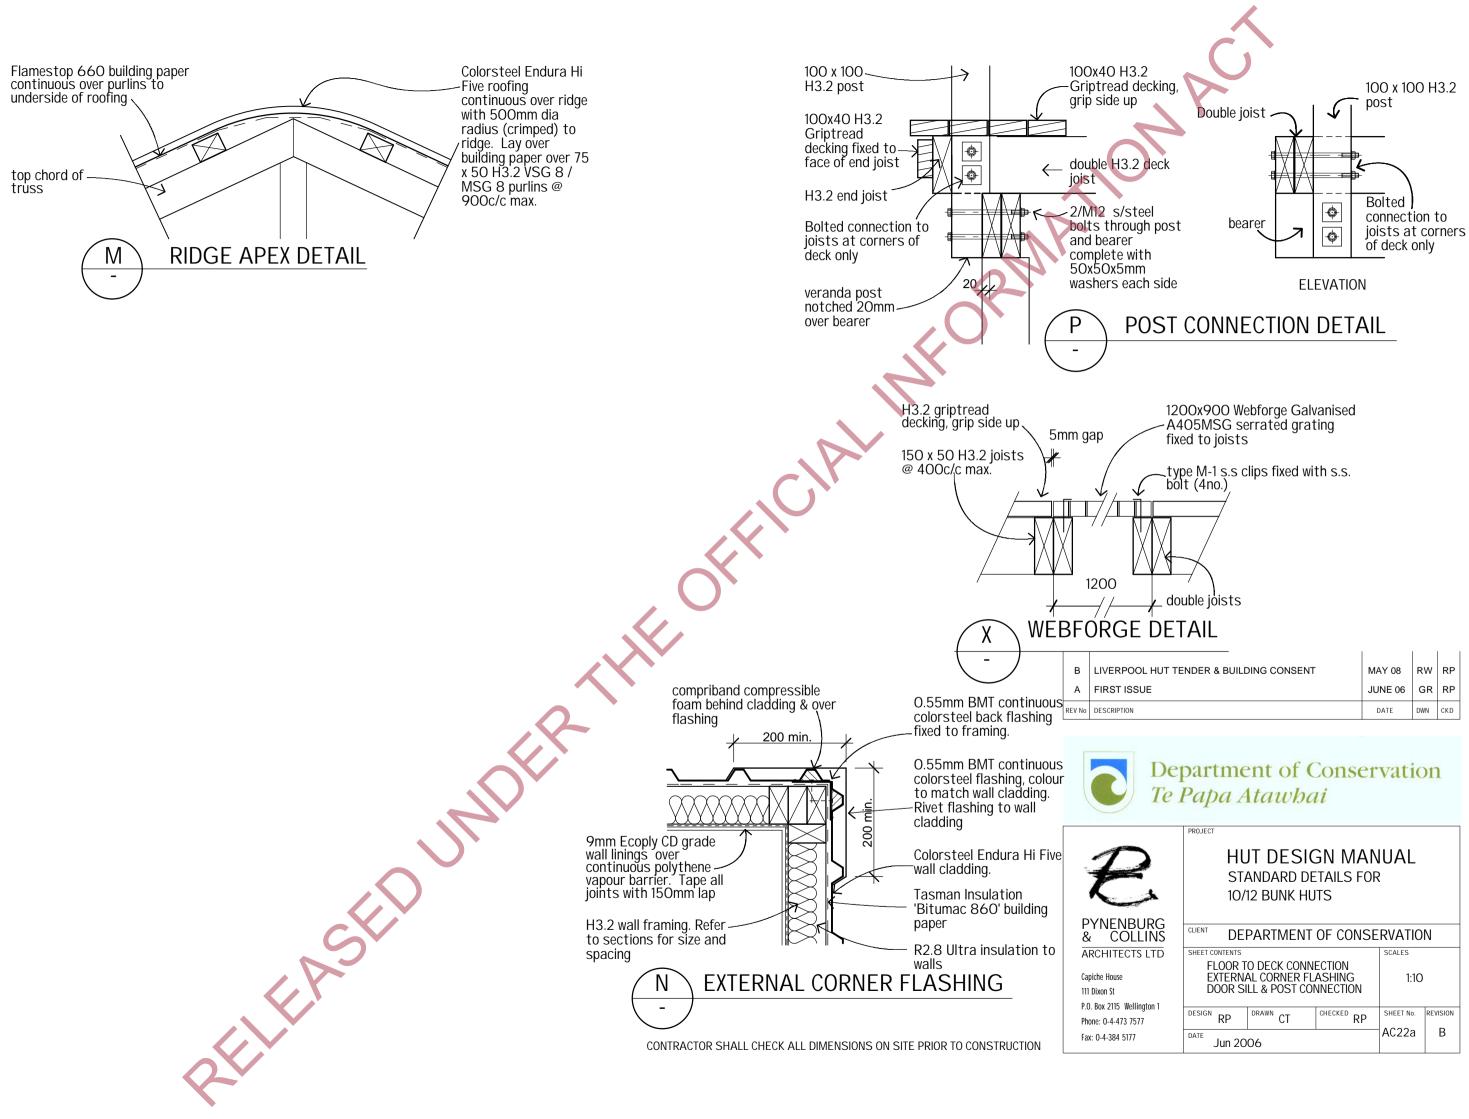


Protecto Sill System comprising Protecto Tak Primer, Protector Wrap Detail Tape (150mm wide), Protecto Wrap Sill tape (a50mm wide) and Protecto Wrap Head Flashing Tape.

Head flashing for windows W4 & W5 to be continuous across both windows. Jamb flahsings to be fitted as detailed. Sill flashings for windows W4 & W5 to be extended so they overlap by 50mm. Fix cut down piece of Hi-Five profile cladding between jambs, with rib down centre-line.

DL HUT TENDER & BUILDING CONSENT	MAY 08 JUNE 06	RW GR	RP RP	
	DATE	DWN	CKD	

Department of Conservation

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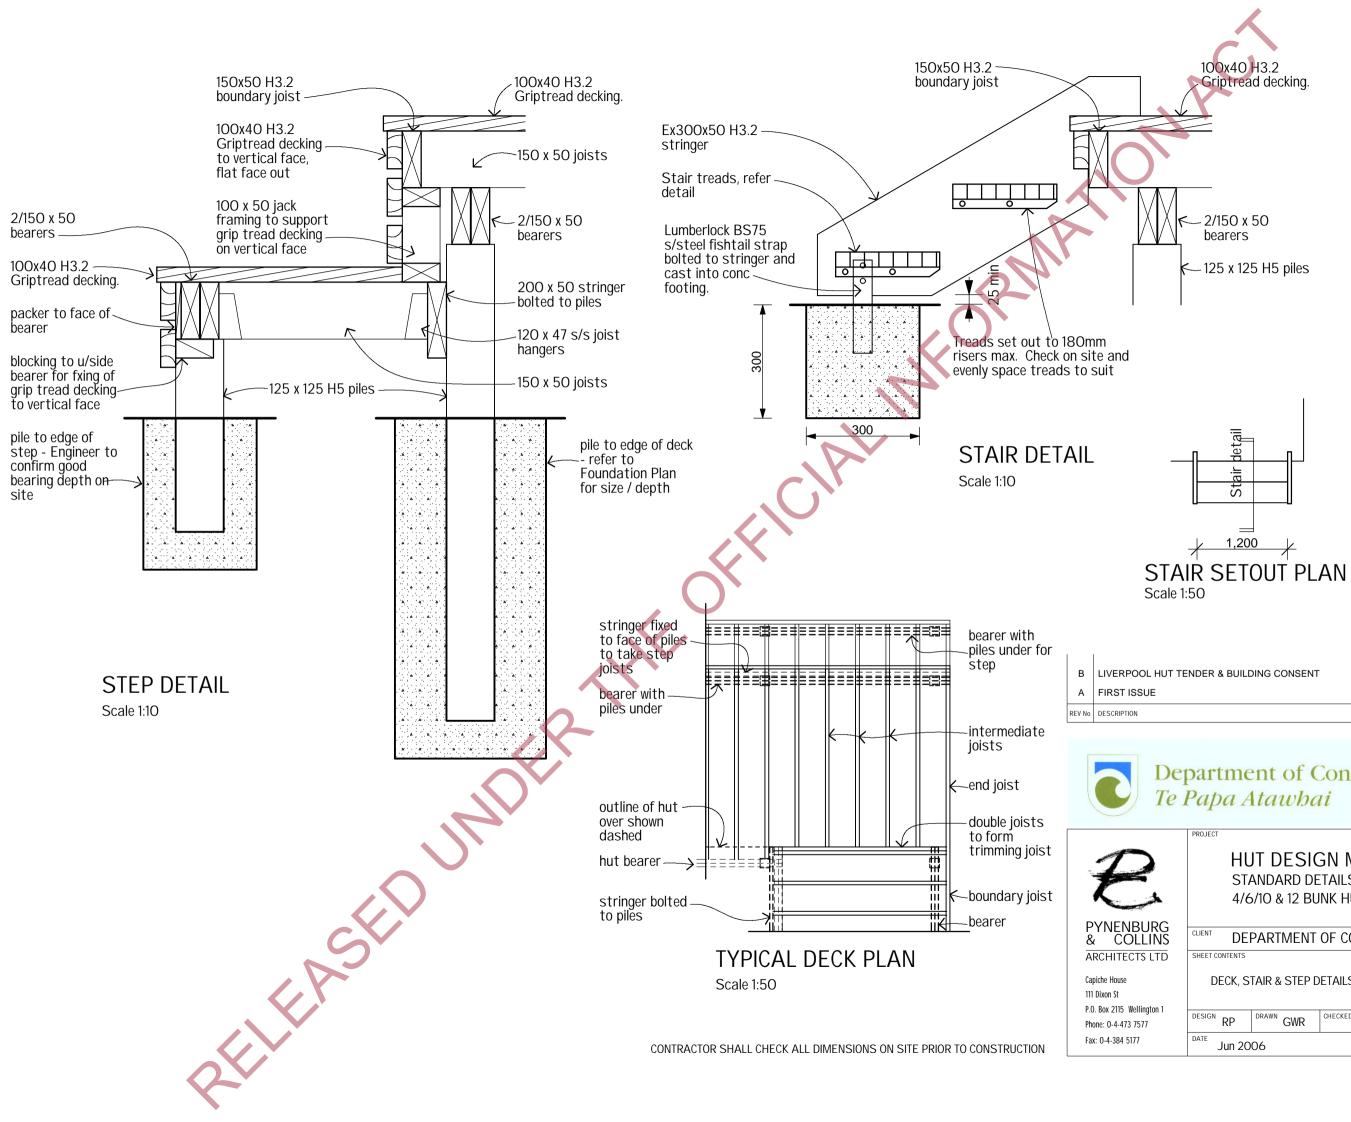


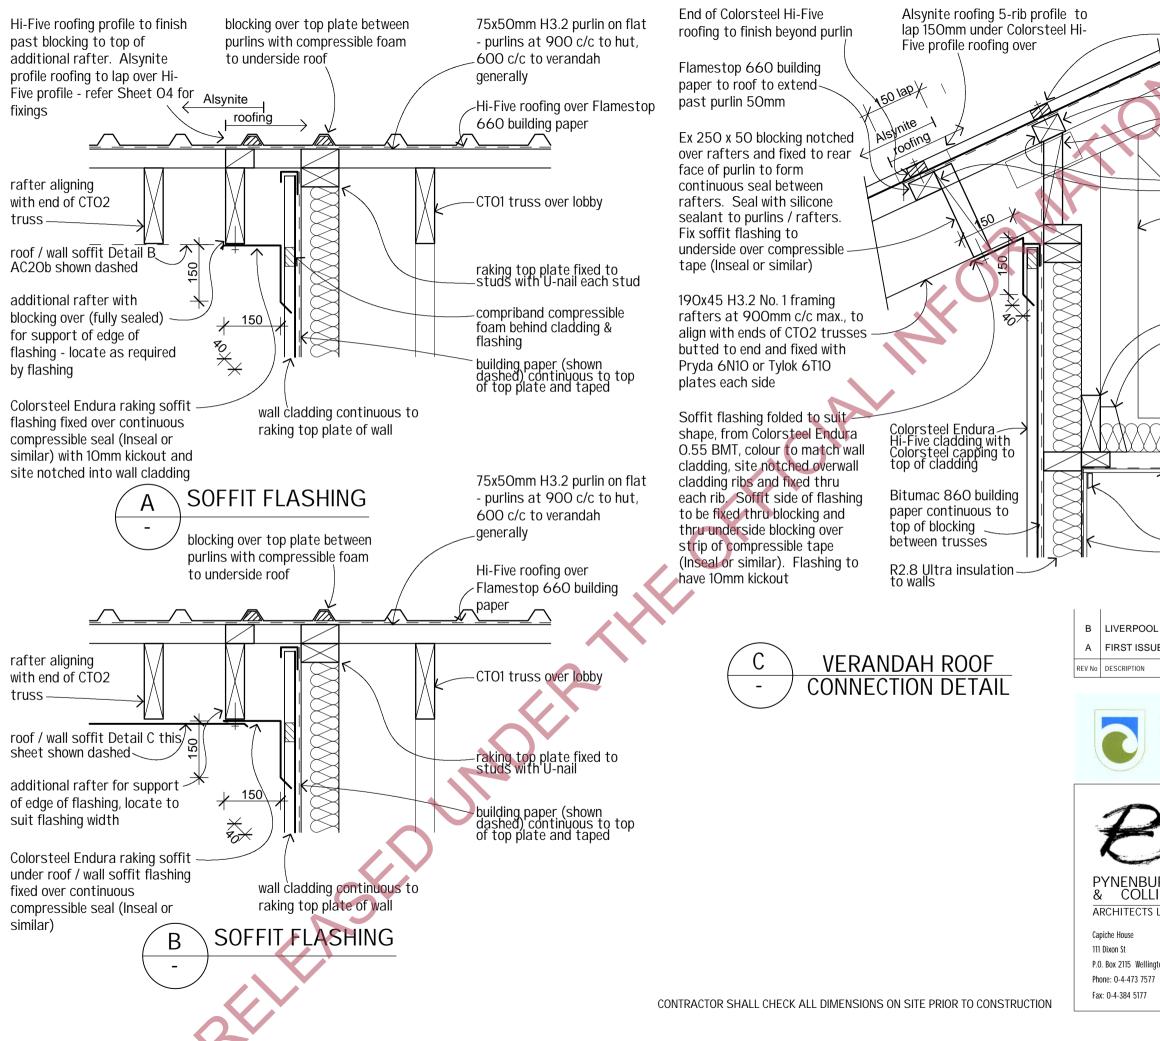Roof profiles to be fixed over			e
Ex 200 x 50 blocking cut be with raking top, seal to trus: fixed directly over for continu	tween tru ses with uous sea	usse purli I	s n
75x50 H3.2 Purlins @ 600 overandah, 900 c/c to hut ro (except for first purlin up frc of roof - refer other details	of		
Mitek truncated truss CTO2	2 H1.2		
150x50mm H3.1 plate fixed f 14g x 100 Type 17 screws at max. Trusses fixed to plate stainless steel joist hanger.	400mm	c/c	/
R3.6 Ultra insulation batts	to ceiling)	
9mm H1.2 Ecoply CD grade u ceiling / wall lining over polyth 40 H1.2 battens @ 600c/c trusses. Polythene to be dir wall or ceiling ply. Polythene continuous behind ceiling / c and wall. 40x12 single bevel	hene over to under ectly ber lining to oved ceili	r 75 side nind be	х
DL HUT TENDER & BUILDING CONSENT	MAY 08	RW	RP

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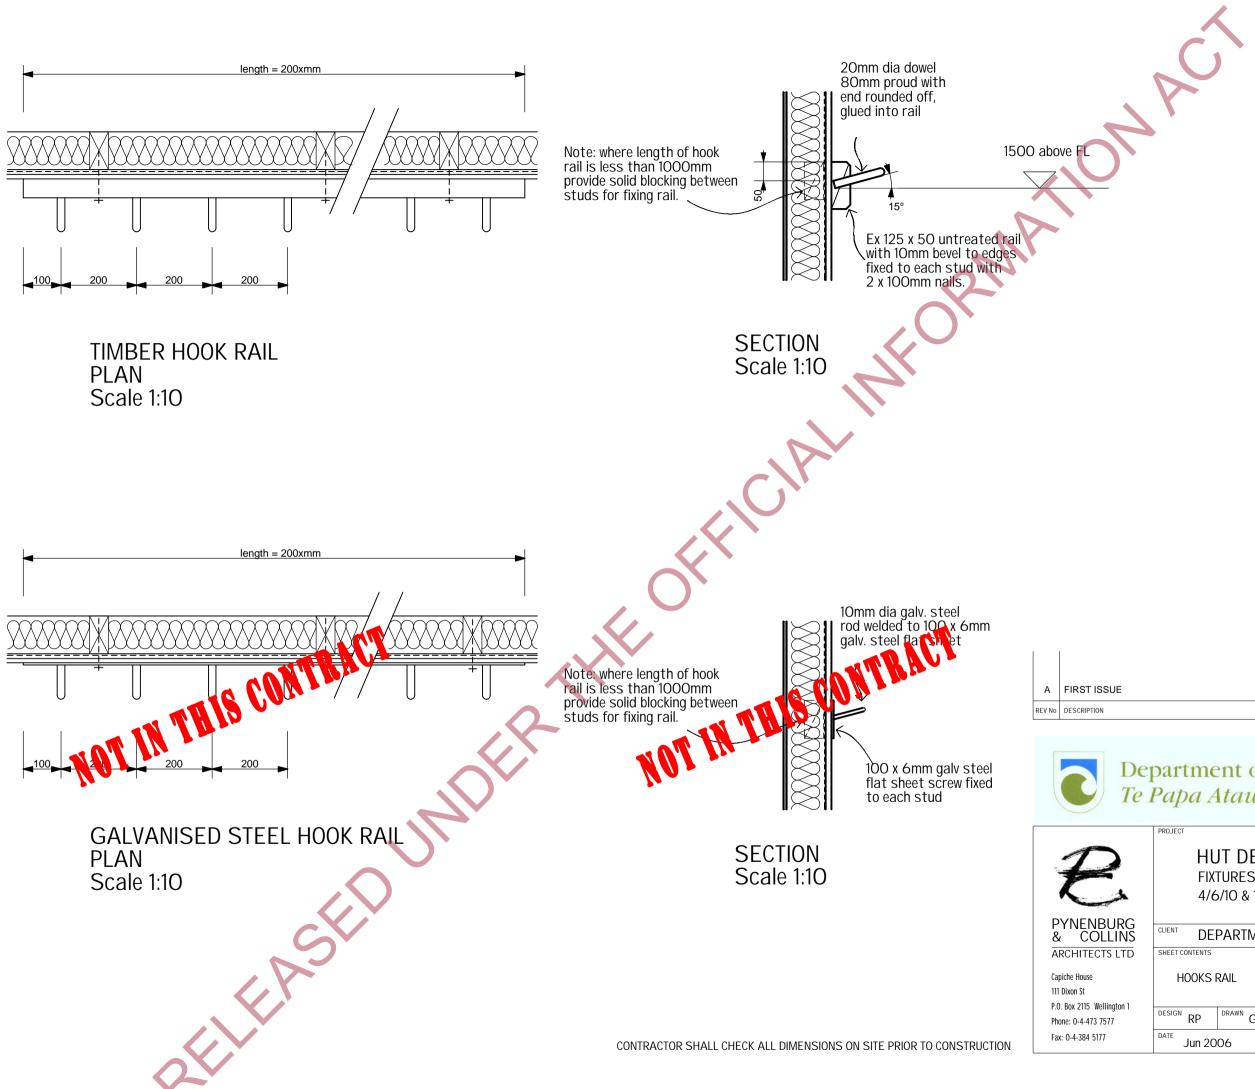
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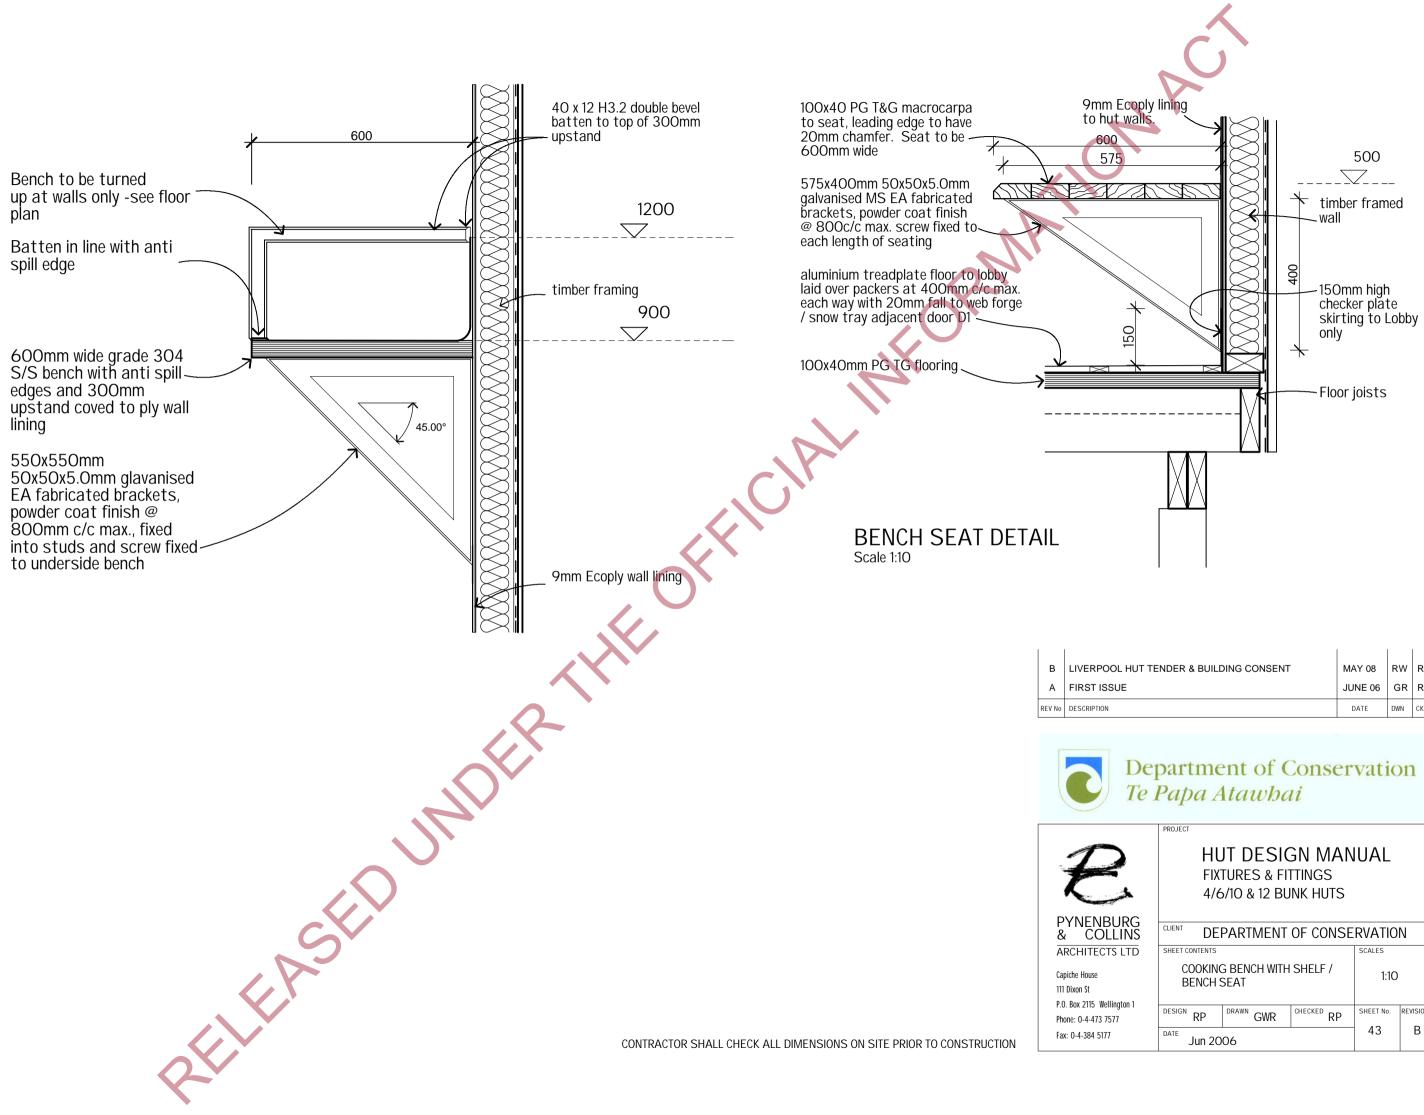
Department of Conservation

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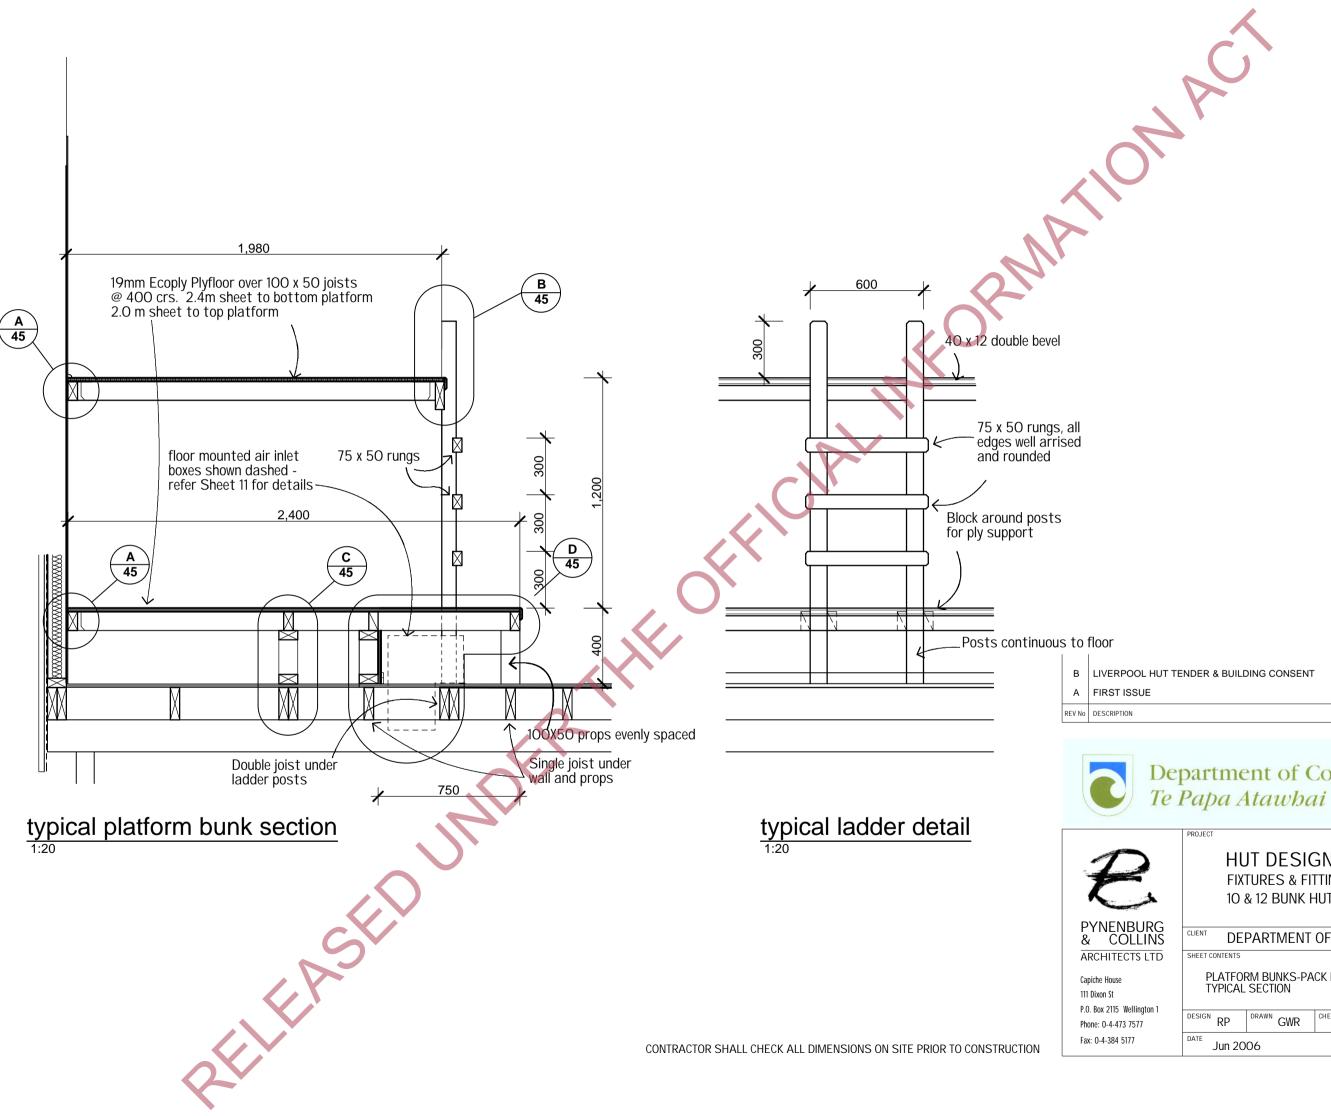
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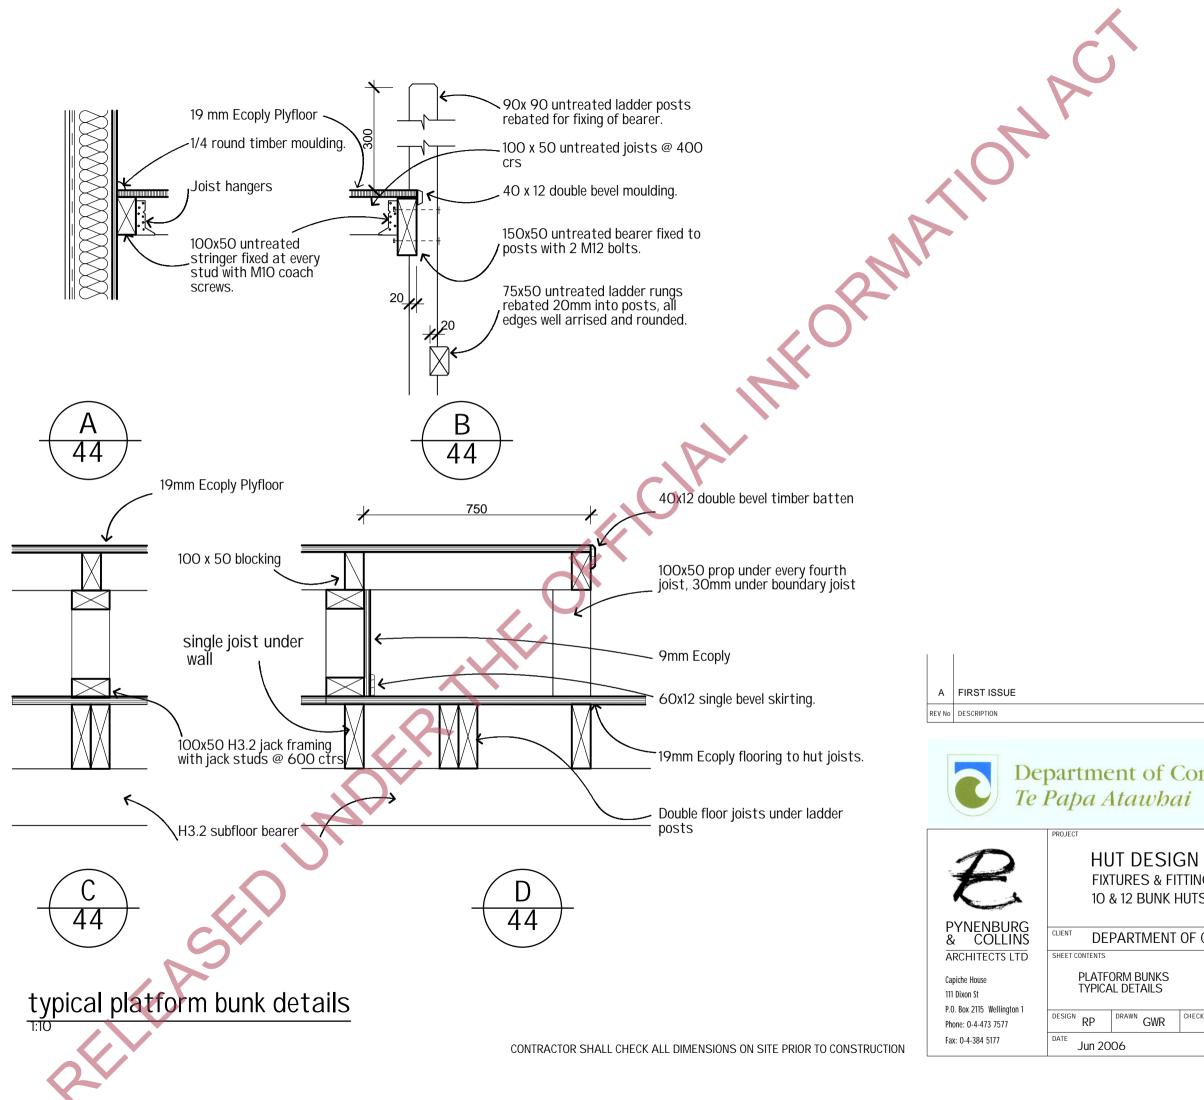
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OL HUT TENDER & BUILDING CONSENT	MAY 08	RW	RP	
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	PROJECT					
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A A A A A A A A A A A A A A A A A A A	4/0	0/10 & 12 BU	INK HUIS			
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	COOKING BENCH WITH SHELF / BENCH SEAT			1:10		
ington 1 77	DESIGN RP	DRAWN GWR	CHECKED RP	SHEET No.	REVISION	
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OL HUT TENDER & BUILDING CONSENT	MAY 08	RW	RP	
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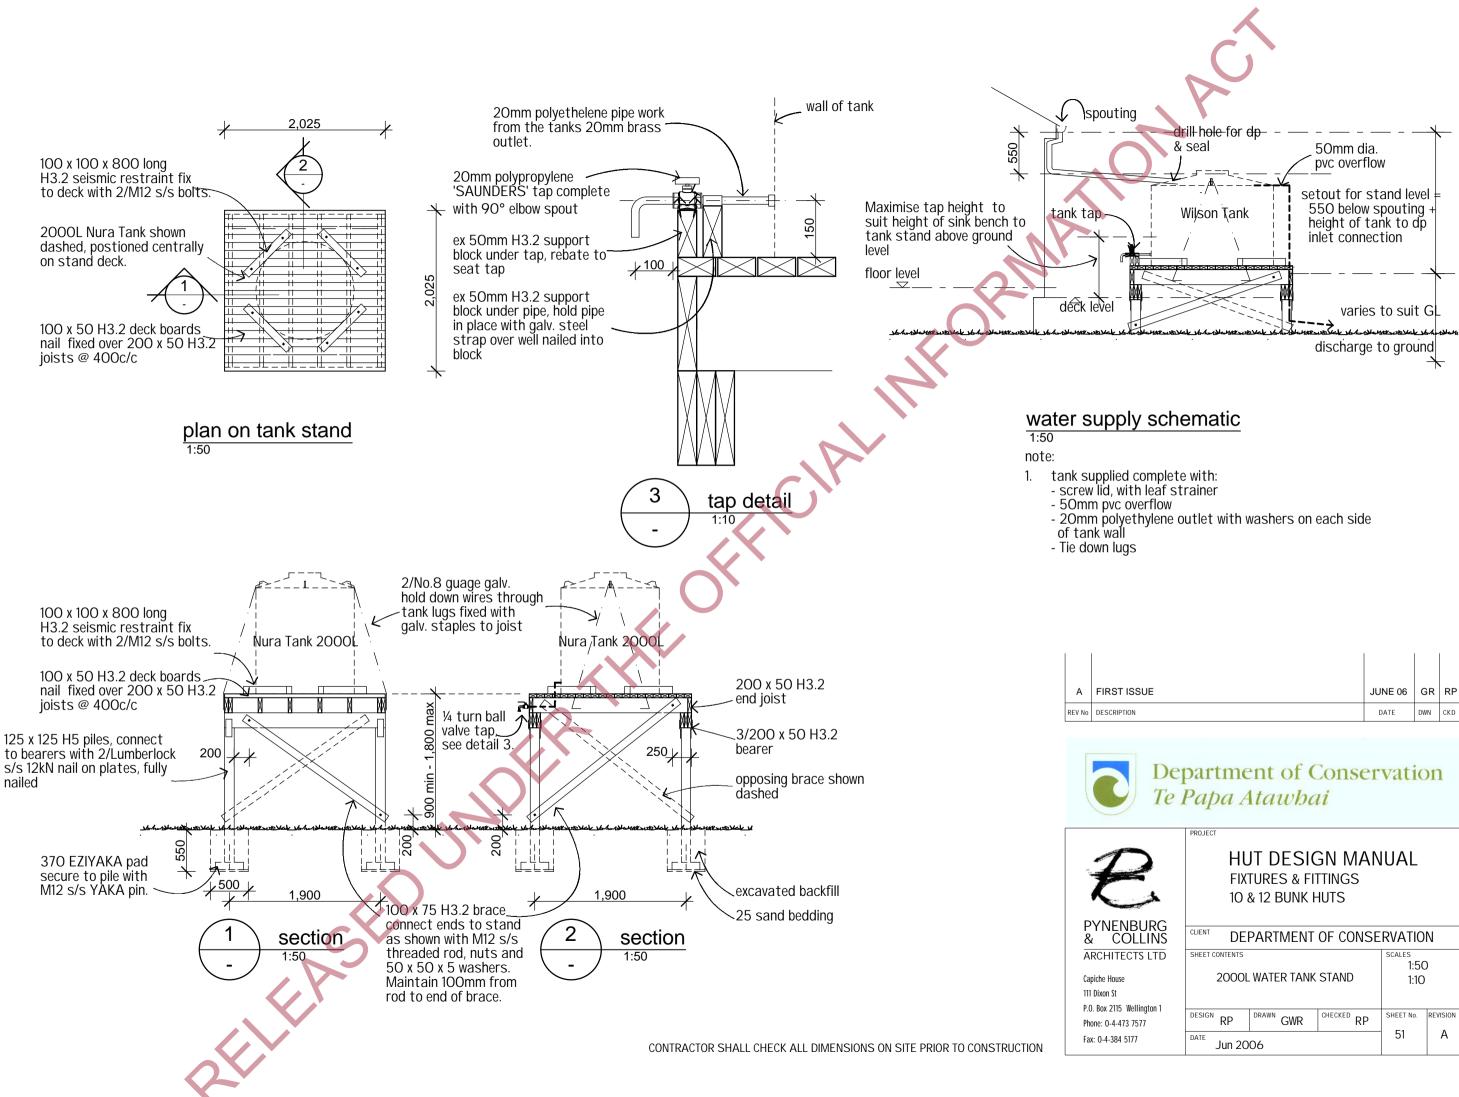
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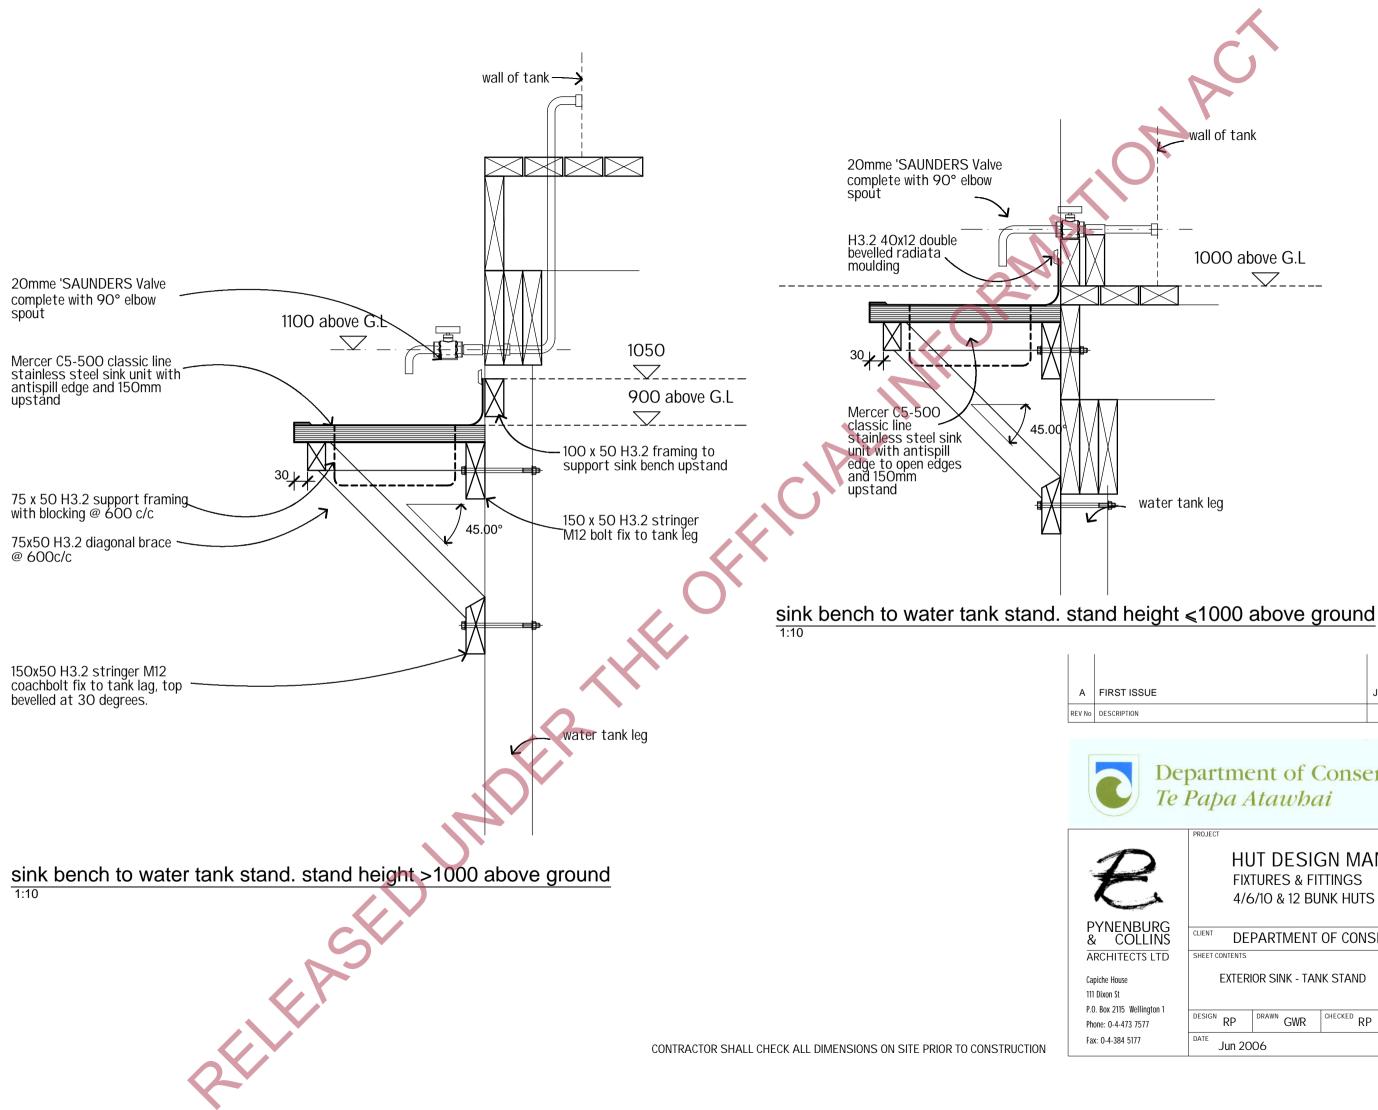
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	Jun 20	06		45	A




SUE	JUNE 06	GR	RP
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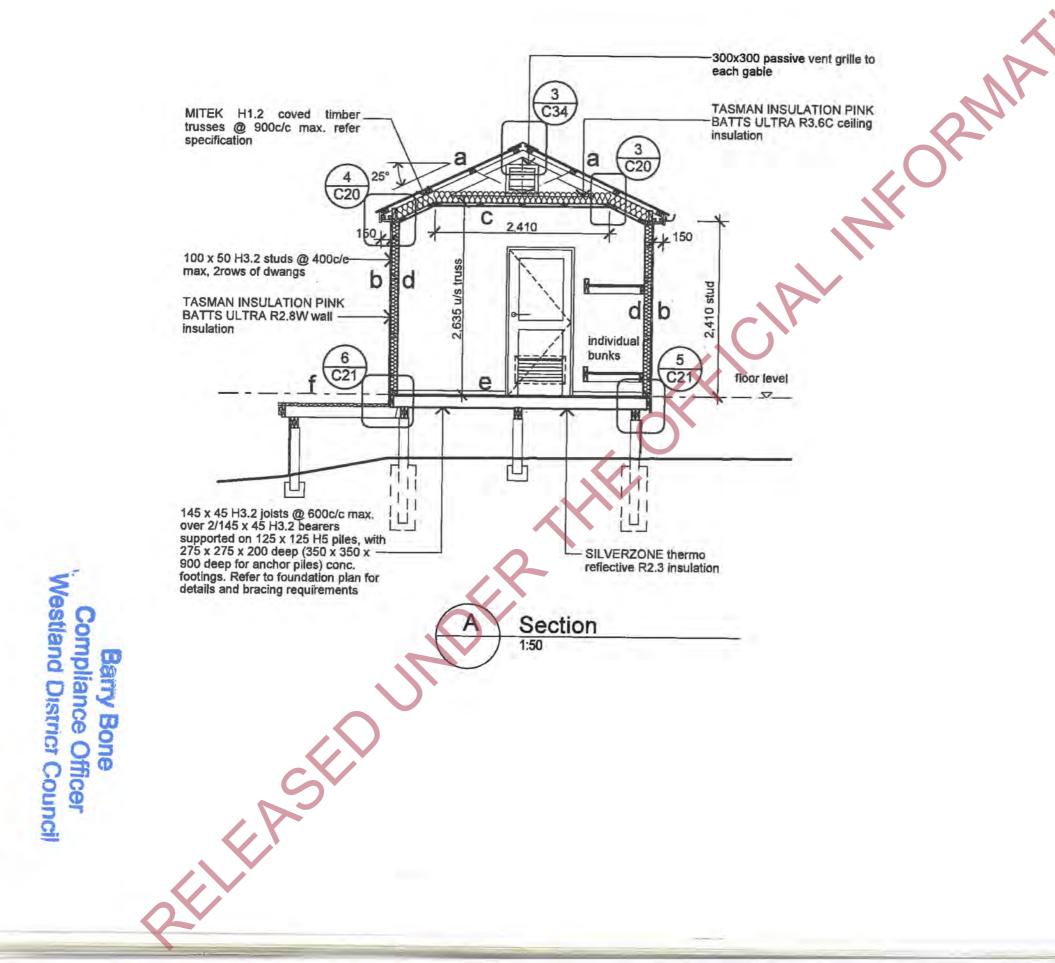
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ngton 1 '7	DESIGN RP	DRAWN GWR	CHECKED RP	SHEET No.	REVISION
	DATE Jun 20	06		51	A



SUE	JUNE 06	GR	RP	
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	FIX	JT DESIC	ITINGS	IUAL	
JRG LINS		5/10 & 12 BU PARTMENT		RVATIO	N
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ngton 1	EXTER	IOR SINK - TAN	IK STAND	1:10	
17		DRAWN GWR	CHECKED RP	SHEET No.	REVISION
1	DATE Jun 20	0		53	А



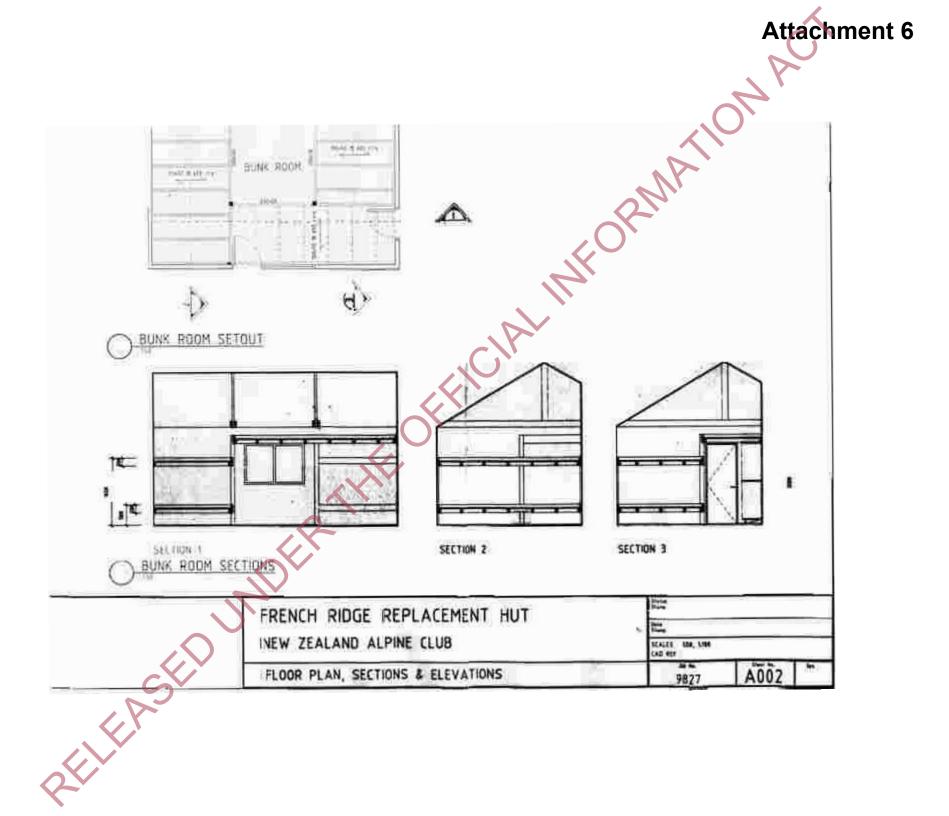

ahura Hut.pln s\0901 hutt0901 Drawing Arahura rts CAD\0901 Lower J:\Clier

Attachment 7


Material Note:

a

b

- COLORSTEEL ENDURA 0.40BMT CORRUGATE PROFILE roofing over TASMAN INSULATION FLAMESTOP 660 building paper over 70 x 45 H3.2 purlins on flat @ 800c/c max. evenly spaced.
- COLORSTEEL ENDURA 0.40BMT CORRUGATE PROFILE cladding over TASMAN INSULATION BITUMAC 860 building paper over timber framing. Refer to floor plan for framing sizes & c/c.
- CHH 9mm ECOPLY CD grade untreated С ceiling lining over 70 x 35 H1.2 battens @ 600c/c max.
- CHH 9mm ECOPLY CD grade untreated d wall lining with 10mm gap to flooring.
- CHH 19mm ECOPLY CD grade H3.2 е LONGSPAN flooring F8 over timber joists. Refer to foundation plan for sub floor framing sizes & c/c.
- 90 x 35 H3.2 grip tread decking, grip side up, even nail spacing. 10mm gap between first piece of decking and wall cladding. Refer to foundation plan for sub floor framing sizes & c/c.

A	Tender & Bullding Con Developed Design	sent	Mar 09 Feb 09	DD	RP
REV No	DESCRIPTION		DATE	DWN	CKD
	ing Issue and Amendmen				
V4.0	Standard Visitor 6 Bunk !	lut - Appendi	x B2.2 - De	tck Op	tion
	1	Capich	e House		
	- Les		ixon St		
		P.O.Bo	x 2115		
	n inte	Wellin	gton 6140		
	PYNENBURG	Phone	04 - 473	577	
	& COLLINS	Fax: 0	4 - 384 517	77	
	ARCHITECTS LTD	www.p	c-architects	.co.nz	
Contra	ictor shall check all Dime			constru	ction
Contra	ictor shall check all Dime	trod i k		constru	ction
PROJEC	Contractor A	tt ol-15 hoosin/	0.411	(ter)	tion
PROJEC	LOWERA	RAHUR	0.411	(ter)	tion
PROJEC	LOWERA	RAHUR	АНЛ	r	ction
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PROJECT	LOWER AL ARAHURA R WAITAKI HIS	RAHUR MER TORIC R	A HU	r /E	
PROJECT	LOWER AN ARAHURA R WAITAKI HIS RIEE HOKITIKA AF	RAHUR MER TORIC R	A HU ESERVICE	r /E	
PROJECT	LOWER AN ARAHURA R WAITAKI HIS MIEE HOKITIKA AF ONTENTS Section A	RAHUR MER TORIC R REA OFF	ESERV ICE	r /E IS SREET	SIZE
PROJECT	LOWER AL ARAHURA R WAITAKI HIS FICE HOKITIKA AF	RAHUR MER TORIC R	ESERV ICE scall 1:5 e A3	Г /Е 50	SIZE EV Na.

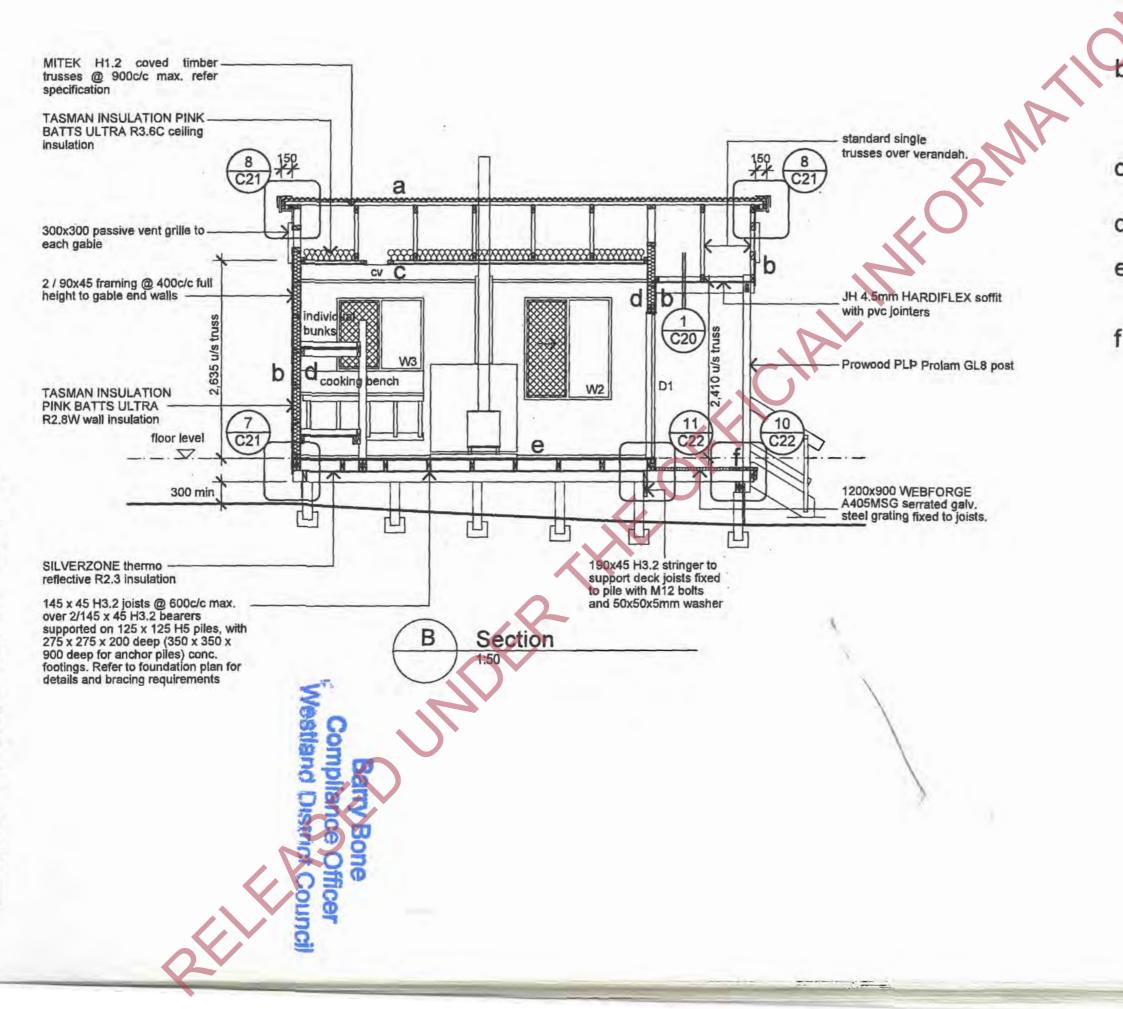

J:IClients CAD/0901 Lower Arahura huti0901 Drawing Documents/0901 Lower Arahura Hut.phn

Material Note:

- a COLORSTEEL ENDURA 0.40BMT CORRUGATE PROFILE roofing over TASMAN INSULATION FLAMESTOP 660 building paper over 70 x 45 H3.2 purlins on flat @ 800c/c max. evenly spaced.
 - COLORSTEEL ENDURA 0.40BMT CORRUGATE PROFILE cladding over TASMAN INSULATION BITUMAC 860 building paper over timber framing. Refer to floor plan for framing sizes & c/c.
- C CHH 9mm ECOPLY CD grade untreated ceiling lining over 70 x 35 H1.2 battens @ 600c/c max.
- d CHH 9mm ECOPLY CD grade untreated wall lining with 10mm gap to flooring.
- CHH 19mm ECOPLY CD grade H3.2 LONGSPAN flooring F8 over timber joists. Refer to foundation plan for sub floor framing sizes & c/c.
 - 90 x 35 H3.2 grip tread decking, grip side up, even nail spacing. 10mm gap between first piece of decking and wall cladding. Refer to foundation plan for sub floor framing sizes & c/c.

A	Tender & Building Conser Developed Design	R.	Mar 09 Feb 09	DD	RP
REV No	DESCRIPTION		DATE	DWN	CKD
Drawi	ng Issue and Amendments				
V4.0 5	Standard Visitor 6 Bunk Hut	- Appendi	x 81.2	*	
	1	Capich	e House		
	-	111 D	ixon St		
	-	P.O.B	x 2115		
	1	Wellin	gton 6140		
	PYNENBURG	Phone	:04 - 473	7577	
	& COLLINS	Fax: B	4 - 384 51	77	
	ARCHITECTS LTD	www.p	c-architect	s.co.nz	
Contra	Ctor shall check all Dimens	1000	-	-	-
100	Department Te Digar ap		ivern	0110	-
PROJEC	LOWERAR	AHUF	ivern	0110	-
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PROJECT	LOWER AR ARAHURA RIN WAITAKI HIST	AHUR ÆR ORIC F	RESER	T	-
PROJECT	LOWERAR ARAHURA RIN WAITAKI HIST	AHUR ÆR ORIC F	RESER	T	-
PROJECT	LOWER AR ARAHURA RIN WAITAKI HIST	AHUR ÆR ORIC F	RESER	T	-
PROJECT	LOWER AR ARAHURA RI WAITAKI HIST	AHUR ÆR ORIC F	RESER ICE	T	-
PROJECT	LOWER AR N ARAHURA RIN WAITAKI HIST HOKITIKA ARE ONTENTS	AHUR ÆR ORIC F	RESER ICE	T WE	-
PROJECT LOCATIC AREA OF	LOWER AR ARAHURA RM WAITAKI HIST FICE HOKITIKA ARE ONTENTS Section B	AHUR ÆR ORIC F	RESER	T VE LES 50	1 SIZE
PROJECT	LOWERAR MARAHURA RIV WAITAKI HIST FILE HOKITIKA ARE ONTENTS Section B	AHUR ÆR ORIC F	RESER	T VE 50	1 SIZE REV NJ.

Attachment 8

